

CITY OF INGLEWOOD, CALIFORNIA PUBLIC WORKS DEPARTMENT PROJECT TITLE: PLANS FOR IMPROVEMENT OF CENTURY BOULEVARD DOTY AVE TO VAN NESS AVE TRAFFIC SIGNAL KEY PLAN

HORIZONTAL

TS-400 5/18/2015 SHEET NO. 96 OF 215

S.

GENERAL NOTES

- 1. ALL WORK, MATERIALS AND EQUIPMENT SHALL BE FURNISHED BY THE CONTRACTOR AND SHALL CONFORM TO CALTRANS 2010 STANDARD PLANS, AND STANDARD SPECIFICATIONS, AND 2012 CALIFORNIA MANUAL OF UNIFORM TRAFFIC CONTROL DEVICES (MUTCD).
- 2. THE CONTRACTOR SHALL OBTAIN ALL NECESSARY PERMITS AND NOTIFY ALL AFFECTED UTILITY COMPANIES AND AGENCIES AT LEAST 72 HOURS IN ADVANCE OF CONSTRUCTION.
- 3. POLE, DETECTOR AND EQUIPMENT LOCATIONS ARE APPROXIMATE. THE ENGINEER SHALL APPROVE THE EXACT LOCATIONS OF ALL EQUIPMENT PLACEMENT IN THE FIELD PRIOR TO INSTALLATION. CONTRACTOR SHALL POTHOLE CONFLICTING UTILITIES AS DIRECTED BY THE ENGINEER.
- 4. ALL VEHICLE INDICATIONS SHALL BE 12" DIAMETER WITH METAL BACK PLATE AND METAL VISOR. SIGNAL SECTION HOUSING SHALL BE METAL, VEHICLE INDICATIONS SHALL BE (RED. YELLOW AND GREEN) AND SHALL UTILIZE LIGHT EMITTING DIODE (LED) SIGNAL MODULES. PEDESTRIAN INDICATIONS SHALL UTILIZE INTERNATIONAL SYMBOL AND UTILIZE LED COUNT DOWN MODULES. PEDESTRIAN BUSH BUTTONS SHALL BE TYPE "B" ADA TYPE WITH INTERNATIONAL SYMBOL PLATE.
- 5. ALL PULL BOXES SHALL BE NO. 5, UNLESS OTHERWISE NOTED, AND HAVE A MAXIMUM SPACING OF 200' BETWEEN PULL BOXES. PULL BOXES AND COVERS SHALL BE CONCRETE. COVERS SHALL HAVE THE MARKING "TRAFFIC SIGNAL." PULL BOX ADJACENT TO THE CONTROLLER CABINET SHALL BE TYPE 6E. PULL BOXES WITH 4 OR MORE CONDUITS SHALL BE TYPE 6E.
- 6. FLASHING SIGNAL OPERATION SHALL BE RED ON ALL PHASES.
- 7. ALL TRAFFIC SIGNAL INTERCONNECT CONDUIT SHALL BE TYPE 3, SCHEDULE 80, UNLESS OTHERWISE NOTED, WITH MIN 30" COVER.
- 8. TRAFFIC SIGNAL INTERCONNECT SHALL BE INSTALLED WITH 6 PAIR 19 SIGNAL INTERCONNECT CABLE, IN A COMMON TRENCH. REFER TO ELECTRICAL PLANS.
- 9. ALL WI FI AND VIDEO DETECTOR LOCATIONS AND INSTALLATIONS SHALL BE VERIFIED IN THE FIELD BY THE ENGINEER OR HIS DESIGNATED REPRESENTATIVE BEFORE SAW CUTTING. NECESSARY STRIPING SHALL BE LOCATED PRIOR TO POSITIONING THE DETECTORS.
- 10. INSTALL #8 GROUND CONDUCTOR IN ALL NEW INSTALLED CONDUITS CONTAINING POWER CONDUCTORS AND A #10 GROUND CONDUCTOR IF CONDUIT CONTAINS NO POWER CONDUCTORS.
- 11. TRÄFFIC SIGNAL SAFETY LIGHTING LUMINARIES SHALL BE 196 WATT LED WITH TYPE III MEDIUM CUTOFF DISTRIBUTION. REFER TO PROJECT SERVICE NOTE, E-411, E-412.
- 12. CONDUCTOR SCHEDULE IS FURNISHED AS AN INSTALLATION GUIDELINE ONLY. IT SHALL BE THE CONTRACTOR'S RESPONSIBILITY TO PROVIDE THE CORRECT CABLES AND CONDUCTORS REQUIRED FOR THE INTENDED OPERATION.
- 13. SERVICE EQUIPMENT ENCLOSURE SHALL BE 10' TO 15' FROM THE CONTROLLER, AND SEPARATED FROM ALL UTILITY POLES BY A MINIMUM OF 15 FEET, UNLESS OTHERWISE DIRECTED BY THE ENGINEER. REFER TO DETAIL "H" ON PLAN NO. TS-401A
- 14. ALL NEW INSTALLED 1-A POLE FOUNDATIONS SHALL HAVE ANCHOR BOLTS WITH SLEEVE NUTS PER CALTRANS STD. PLAN ES-7B.
- 15. UNDERGROUND SIGNAL CONDUCTORS SHALL NOT BE SPLICED.
- 16. THE CONTRACTOR SHALL BE RESPONSIBLE FOR PROVIDING A DETAILED TRAFFIC CONTROL PLAN FOR ANY STREET AND DRIVEWAY CLOSURES ASSOCIATED WITH THE TRAFFIC SIGNAL CONSTRUCTION AND SHALL PROVIDE ALL NECESSARY TRAFFIC CONTROL DEVICES DURING THE SIGNAL INSTALLATION, IN ACCORDANCE WITH THE 2012 CALIFORNIA MANUAL OF TRAFFIC CONTROL DEVICES (MUTCD).
- 17. FOR STRIPING DETAILS SEE STRIPING AND SIGNING PLANS (PLAN NUMBERS SPD-401 THROUGH SPD-409).
- 18. ALL SIGN PANELS SHALL CONFORM TO THE CALTRANS SIGN AND SPECIFICATION SHEETS AND SHALL BE MOUNTED ON POST AT 7' HEIGHT FROM GROUND.
- 19. THE EXACT LOCATION OF ALL SIGNS AND PAVEMENT MARKINGS SHALL BE DETERMINED BY THE ENGINEER IN THE
- 20. ALL TRAFFIC SIGNS SHALL BE INSTALLED PRIOR TO TRAFFIC SIGNAL TURN ON.
- 21. ALL PAVEMENT DELINEATION REQUIREMENTS SHALL BE COMPLETED AT LEAST ONE DAY PRIOR TO TRAFFIC SIGNAL TURN ON.
- 22. CONDUIT BETWEEN ADJOINING PULL BOXES SHALL BE 2.5" UNLESS SHOWN OTHERWISE.
- 23. WI FI AND VIDEO VEHICLE DETECTORS SHALL BE CENTERED WITHIN THE LANE AND SHALL BE 6 FEFT IN WIDTH. WI FI DETECTORS SHALL BE INSTALLED WITH 1/2 INCH OF CLEARANCE TO TOP OF FINAL PAVEMENT SURFACE. DETECTOR SEALANT SHALL BE HOT MELT RUBBERIZED ASPHALT, PER SECTION 86-5.01A(3)(c) OF THE STANDARD
- 24. PULL BOXES SHALL NOT BE LOCATED IN OR WITHIN 12" OF ANY CURB ACCESS RAMP OR DRIVEWAY.
- 25. THE CONTRACTOR SHALL VERIFY WITH THE ENGINEER THE PRECISE FIELD LOCATIONS OF ALL TRAFFIC SIGNAL EQUIPMENT PRIOR TO THE INSTALLATION.
- 26. ALL LANDSCAPING WHICH IS DAMAGED BY CONSTRUCTION ACTIVITIES SHALL BE REPAIRED OR REPLACED TO THE SATISFACTION OF THE CITY.
- 27. NEW MAST ARM MOUNTED REGULATORY SIGNS SHALL BE FABRICATED WITH ASTM TYPE II REFLECTIVE SHEETING OR
- 28. STREET NAME SIGNS (SNS) SHALL BE REFLECTORIZED PER SPECIFICATIONS. STREET NAME LEGENDS SHALL BE UPPER/LOWER CASE, SUBMIT FULL SIZE COLOR SAMPLE TO THE CITY TRAFFIC ENGINEER FOR APPROVAL PRIOR TO
- 29. CONTRACTOR SHALL COORDINATE WITH THE CITY OF INGLEWOOD TRAFFIC SIGNAL MAINTENANCE DEPARTMENT FIVE (5) WORKING DAYS PRIOR TO WORK AFFECTING A TRAFFIC SIGNAL.
- 30. PEDESTRIAN PUSH BUTTONS SHALL BE ADA COMPLIANT AND VIBRO TACTILE. PUSH BUTTONS SHALL BE CONSTRUCTED OF HIGH DENSITY THERMOPLASTIC AND UTILIZE PIEZO SWITCH TECHNOLOGY. PUSH BUTTON COLOR

GENERAL NOTES CONTINUED

SHALL BE YELLOW. OUTER BODY COLOR SHALL BE BLACK. POLARA *MPBP-BY OR CAMPBELL CO. DCC 700P OR EQUAL. SCREWS USED TO SECURE THE SIGN PLATE TO THE HOUSING SHALL BE STAINLESS STEEL 8-32" X 3/8" WITH TAMPER PROOF TORX HEAD. SIZE T-15, OR A CITY APPROVED EQUAL. SUBMIT SAMPLE TO THE CITY TRAFFIC ENGINEER FOR APPROVAL PRIOR TO ORDERING PUSH BUTTON SYSTEMS.

- 31. THE CONTRACTOR SHALL OBTAIN ALL NECESSARY PERMITS AND SHALL NOTIFY ALL AFFECTED AGENCIES AND COMPANIES, INCLUDING THE CITY OF INGLEWOOD, TRAFFIC SIGNAL MAINTENANCE DIMSION, 48 HOURS PRIOR TO
- 32. EXISTING TRAFFIC SIGNAL HEADS AND POLES SHALL BE REMOVED, INCLUDING ENTIRE POLE FOUNDATIONS (BACKFILLED WITH NATIVE MATERIAL TO 95% RELATIVE COMPACTION) UNLESS NOTED OTHERWISE.
- 33. EXISTING TRAFFIC SIGNAL CONTROLLER CABINETS THAT ARE TO REMAIN IN PLACE AND REUSED, SHALL BE PROTECTED IN PLACE.
- 34. ALL EXISTING CONDUITS NOT SHOWN FOR REUSE SHALL BE ABANDONED.
- 35. ALL EXISTING PULLBOXES NOT SHOWN FOR REUSE SHALL BE REMOVED AND BECOME THE PROPERTY OF THE

ABBREVIATIONS

ACCESSIBLE PEDESTRIAN SIGNAL

BATTERY BACKUP SYSTEM (NEW PIGGY BACK) EMERGENCY VEHICLE PREEMPTION DETECTOR

NEW SERVICE, DUAL METER PEDESTAL

STREET LIGHTING

TRAFFIC SIGNAL PHOTO ELECTRIC UNIT

EDGE LIT LED TYPE 'A' STREET NAME SIGN

STANDARD NOTES

AB ABANDON. IF APPLIED TO CONDUIT, REMOVE CONDUCTORS.

BC INSTALL PULL BOX IN EXISTING CONDUIT RUN.

CB INSTALL CONDUIT INTO EXISTING PULL BOX.

CC CONNECT NEW AND EXISTING CONDUIT. REMOVE EXISTING CONDUCTORS AND INSTALL CONDUCTORS AS INDICATED.

PP PROTECT IN PLACE

RC EQUIPMENT OR MATERIAL TO BE REMOVED AND BECOME THE PROPERTY OF THE CONTRACTOR.

RL RELOCATE EQUIPMENT.

RS REMOVE AND SALVAGE EQUIPMENT

LEGEND

DUAL METER SERVICE PEDESTAL EXISTING UTILITY PROPOSED UTILITY EXISTING CCTV CAMERA PROPOSED FIBER OPTIC PROPOSED CCTV CAMERA ----- F0 -----EXISTING FIBER OPTIC PROPOSED 3M OPTICOM DETECTOR

WIFI VEHICLE DETECTOR

PROPOSED VIDEO VEHICLE DETECTION AREA

EXISTING VIDEO VEHICLE DETECTION AREA

CITY OF INGLEWOOD MAINTAINED


PERCENTAGE SHARE 100% CITY OF INGLEWOOD




UNDERGROUND SERVICE ALERT OF SOUTHERN CALIFORNIA





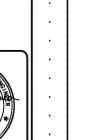

REVISIONS

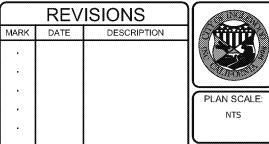

DESIGNED BY

CHECKED B

CITY OF INGLEWOOD, CALIFORNIA PUBLIC WORKS DEPARTMENT PROJECT TITLE

PLANS FOR IMPROVEMENT OF **CENTURY BOULEVARD** DOTY AVE TO VAN NESS AVE


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TRAFFIC SIGNAL PLANS - GENERAL NOTES & LEGEND

5/18/2015

TS-401 SHEET NO 97 OF 215


HORIZONTAL

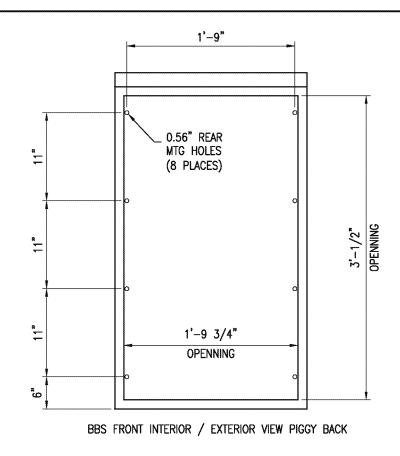



- 1. BBS CABINET SHALL BE ATTACHED TO THE 332 CONTROLLER CABINET WHERE INDICATED ON THE TRAFFIC SIGNAL PLANS. REFER TO DETAIL "F" HEREON.
- 2. THE BBS CABINET SHALL CONTAIN THE UPS AND THE BATTERIES.

BATTERY BACKUP SYSTEM CABINET (BBS)


DETAIL "G" NOT TO SCALE

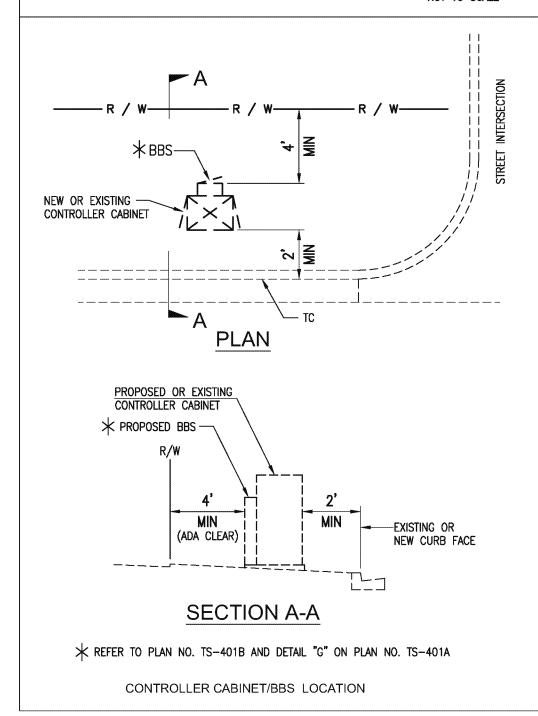

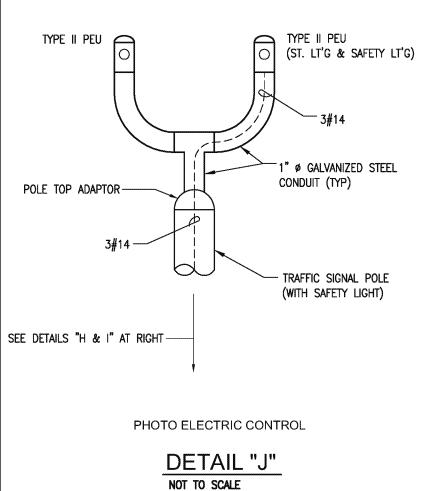

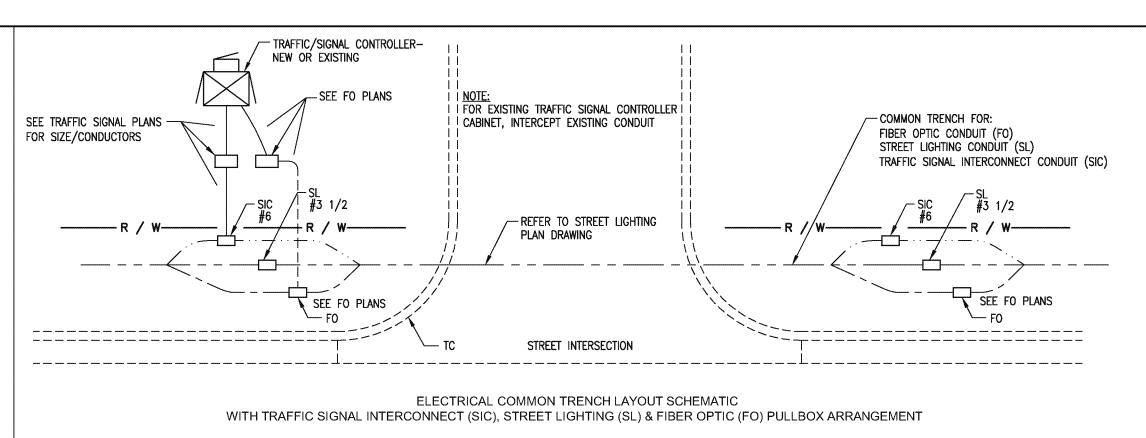


DETAIL "K" NOT TO SCALE

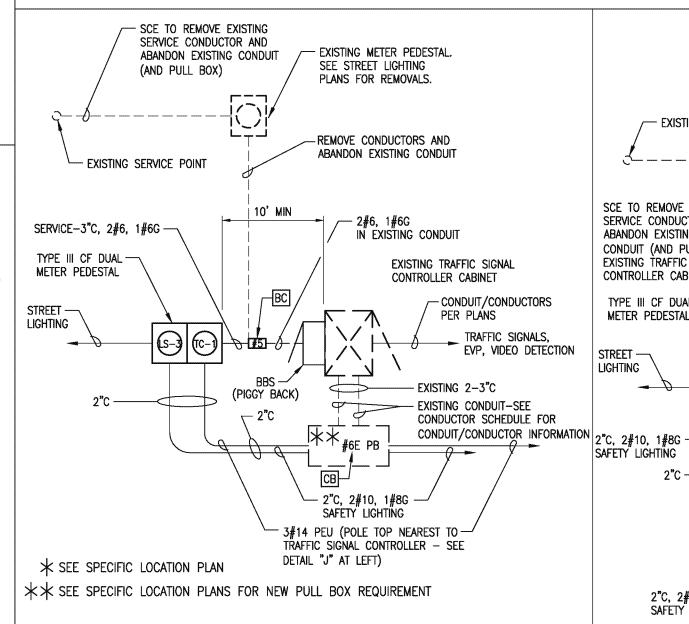

TYPICAL ELECTRICAL SERVICE LAYOUT SCHEMATIC FOR NEW SAFETY / STREET LIGHTING AND *EXISTING TRAFFIC SIGNAL CONTROLLER CABINET

> DETAIL "I" NOT TO SCALE

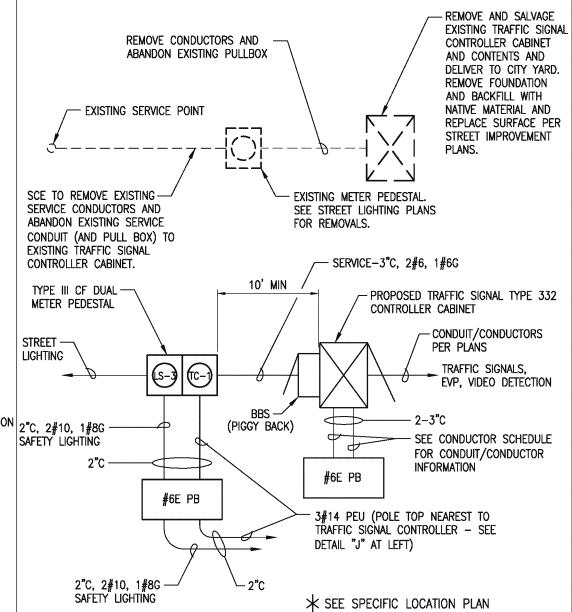

TYPICAL ELECTRICAL SERVICE LAYOUT SCHEMATIC FOR NEW SAFETY / STREET LIGHTING AND *NEW TRAFFIC SIGNAL CONTROLLER CABINET


DETAIL "H" NOT TO SCALE

CITY OF INGLEWOOD, CALIFORNIA

DIAL TOLL FREE 811 UNDERGROUND SERVICE ALERT OF SOUTHERN CALIFORNIA





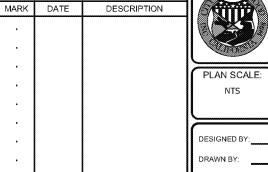

REVISIONS


PUBLIC WORKS DEPARTMENT PLANS FOR IMPROVEMENT OF **CENTURY BOULEVARD** DOTY AVE TO VAN NESS AVE TRAFFIC SIGNAL PLANS - GENERAL NOTES & DETAILS



5/18/2015

ST-4696

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EXTERNAL BBS CABINET MOUNTED TO THE MODEL 332 OR 334 CABINET

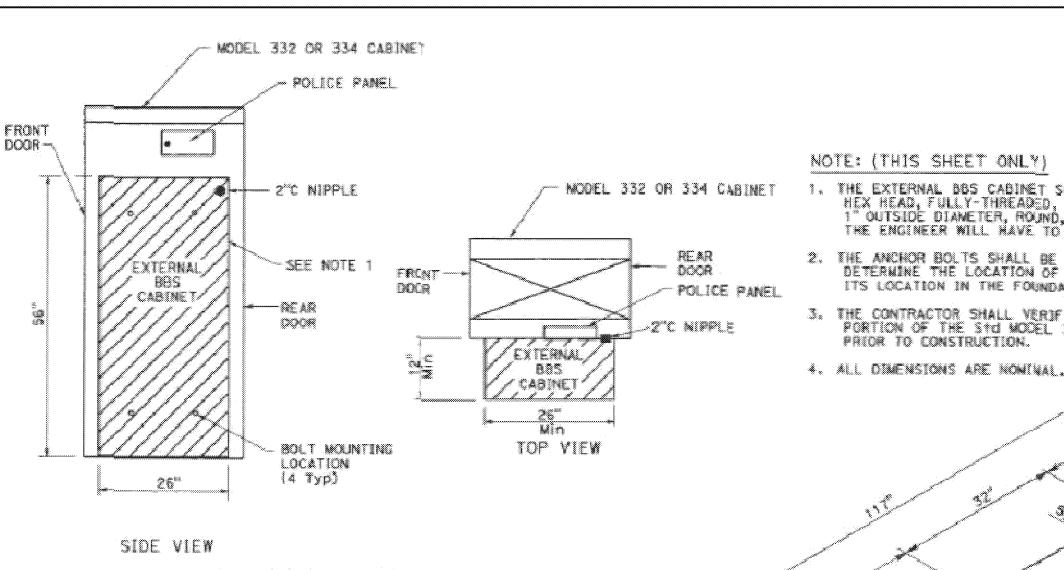WOOEL 332 OR 334 CABINET. ANCHOR BOLTS, 4 Min MODEL 332 OR 334 (SEE NOTE 2) FRONT-DOOR EXTERNAL 885 CABINET ----SEE NOTE I


BASE PLAN FOR BBS MOUNTED TO THE MODEL 332 OR 334 CABINET

(FOR DIMENSIONS AND DETAILS NOT SHOWN, SEE SHEET AS-1 TO AE-4, CADINET HOUSING DETAILS OF THE TRANSPORTATION ELECTRICAL EQUIPMENT SPECIFICATION (TEES)

NOTE: (THIS SHEET ONLY)

- 1. THE EXTERNAL BBS CABINET SHALL BE MOUNTED TO THE MODEL 332 OR 334 CABINET WITH FOUR 18-8 STAINLESS STEEL HEX HEAD, FULLY-THREADED, 1/6-16 X 1/8 BOLTS; TWO WASHERS PER BOLT, DESIGNED FOR 1/8 BOLTS AND ARE 18-8 STAINLESS STEEL, 1/0 OUTSIDE DIAMETER, ROUND, AND FLAT; AND ONE K-LOCK NUT PER BOLT THAT IS 18-8 STAINLESS STEEL AND A HEX-NUT. THE EMGINEER WILL HAVE TO APPROVE THE BOLT WOUNTING LOCATION PRIOR TO INSTALLATION.
- 2. THE ANCHOR BOLTS SHALL BE 7/" DIO X 15" WITH A 2"-90" BEND. THE CABINET WANUFACTURER'S SPECIFICATION SHALL DETERMINE THE LOCATION OF THE ANCHOR BOLTS IN THE FOUNDATION. THE ENGINEER WILL HAVE TO APPROVE THE ANCHOR BOLTS AND ITS LOCATION IN THE FOUNDATION PRIOR TO CONSTRUCTION.
- 3. THE CONTRACTOR SHALL VERIFY THE DIMENSIONS OF THE BBS CABINET PRIOR TO CONSTRUCTING THE FOUNDATION OF THE MODIFIED FORTION OF THE STO MODEL 332 AND 334 CABINET FOUNDATION. THE ENGINEER WILL HAVE TO APPROVE ANY NECESSARY DEVIATIONS PRIOR TO CONSTRUCTION.

(5" × 15")

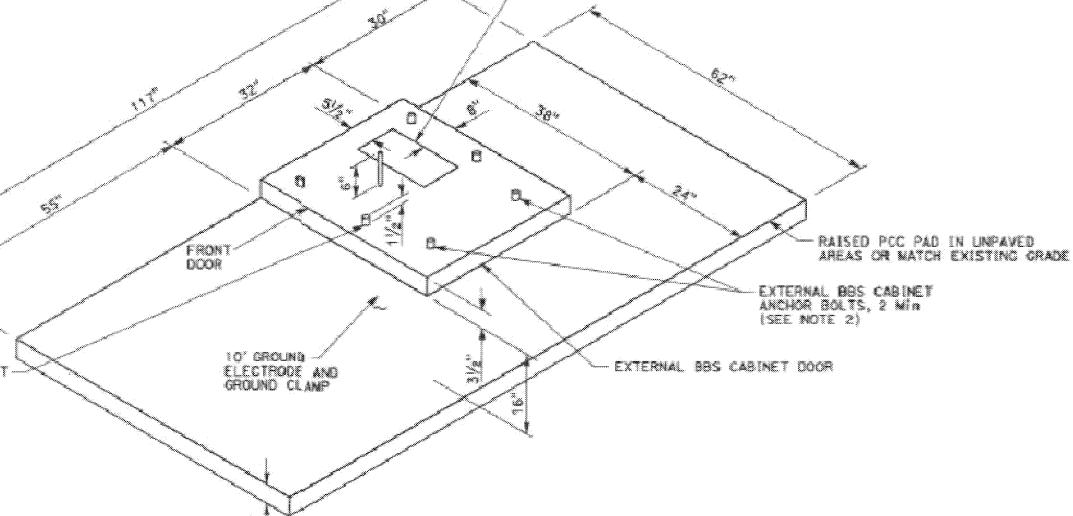

MODIFIED MODEL 332 AND 334 CABINET FOUNDATION DETAIL FOR BATTERY BACKUP SYSTEM (BBS)

(FOR DIMENSIONS AND DETAILS NOT SHOWN AND ADDITIONAL MOTES, SEE SHEET ES-3C OF THE STANDARD PLANS FOR MODEL 332 AND 334 CABINETS)

ELECTRICAL SYSTEMS


(BBS FOUNDATION DETAILS)







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PLANS FOR IMPROVEMENT OF **CENTURY BOULEVARD** DOTY AVE TO VAN NESS AVE **BBS FOUNDATION DETAILS**

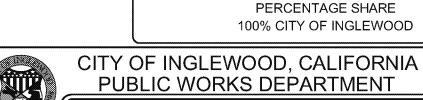5/18/2015


UNDERGROUND SERVICE ALERT OF SOUTHERN CALIFORNIA

CITY OF INGLEWOOD MAINTAINED

APPROACH SPEED. MPH	DISTANCE OF ADVANCE LOOP FROM LIMIT LINE, FT*
25	105
30	140
35	185
40	230
45	285

* PER CHAPTER 4D, CALIFORNIA 2014 MUTCD TABLE 4D-101(CA)


> DETAIL"A" NOT TO SCALE

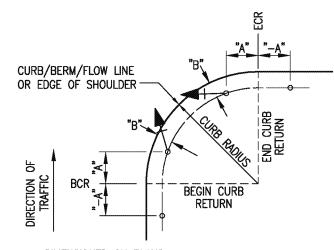

DIMENSIONED ON PLANS. * TYPICAL SIGNAL STANDARD PLACEMENT * FOR "A" AND "B" DIMENSIONS, SEE POLE SCHEDULE


OR AS DIRECTED BY THE ENGINEER.


DETAIL"B" NOT TO SCALE

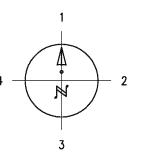

PUSH BUTTON LOCATION


DETAIL"C" NOT TO SCALE

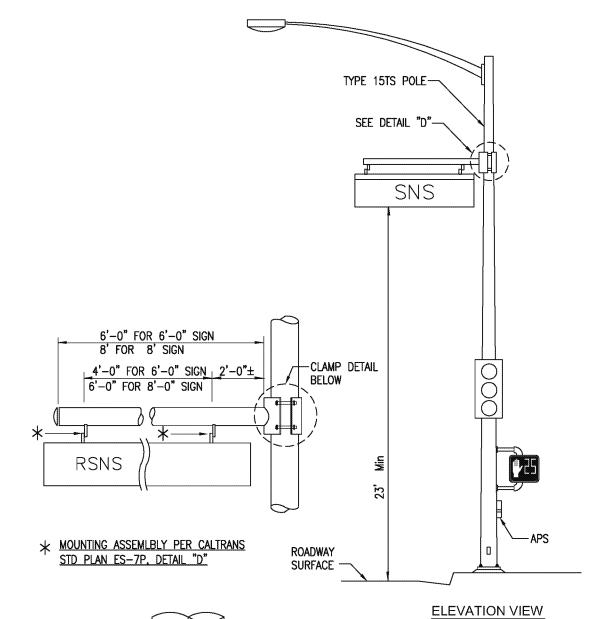

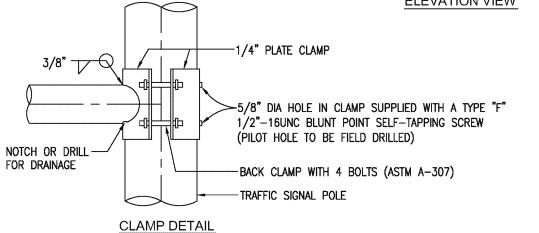

TYPICAL STREET NAME SIGN MAST ARM & MOUNTING FOR TYPE 15 TS

> DETAIL "D" NOT TO SCALE

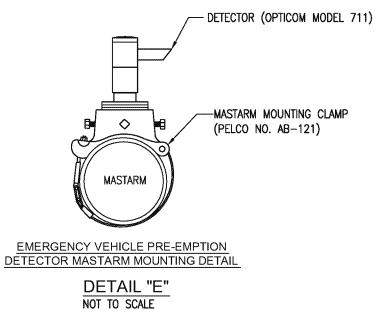

WARNING:


UTILITY LINES SHOWN ARE BASED UPON A SEARCH OF AVAILABLE RECORDS. THERE IS NO ASSURANCE THAT THE LOCATION OF SUBSTRUCTURES SHOWN ARE ACCURATE. PRIOR TO ANY EXCAVATION WORK, THE CONTRACTOR SHALL NOTIFY UNDERGROUND SERVICE ALERT OF SOUTHERN CALIFORNIA (DIGALERT) TO MARK THE LOCATION OF ALL SUBSTRUCTURES, WHETHER SHOWN OR NOT ON THESE DRAWINGS, AT LEAST 48 HOURS PRIOR TO THE COMMENCEMENT OF FIELD MARKING. THE CONTRACTOR SHALL USE PRECAUTION WHEN EXCAVATING. SUBSTRUCTURES ENCOUNTERED SHALL BE EXPOSED AND THE ENGINEER NOTIFIED OF THEIR EXISTENCE. THE CONTRACTOR SHALL BE RESPONSIBLE FOR THE PROTECTION OF ALL SUBSTRUCTURES, WHETHER SHOWN OR NOT, ON THESE DRAWINGS. THE CONTRACTOR SHALL REPAIR, AT OWN EXPENSE, ANY SUBSTRUCTURES DAMAGE CAUSED BY HIS/HER OPERATIONS.







	MARK	DATE	DESCRIPTION	
				DI AN COAL
١				PLAN SCAL 1"=20'
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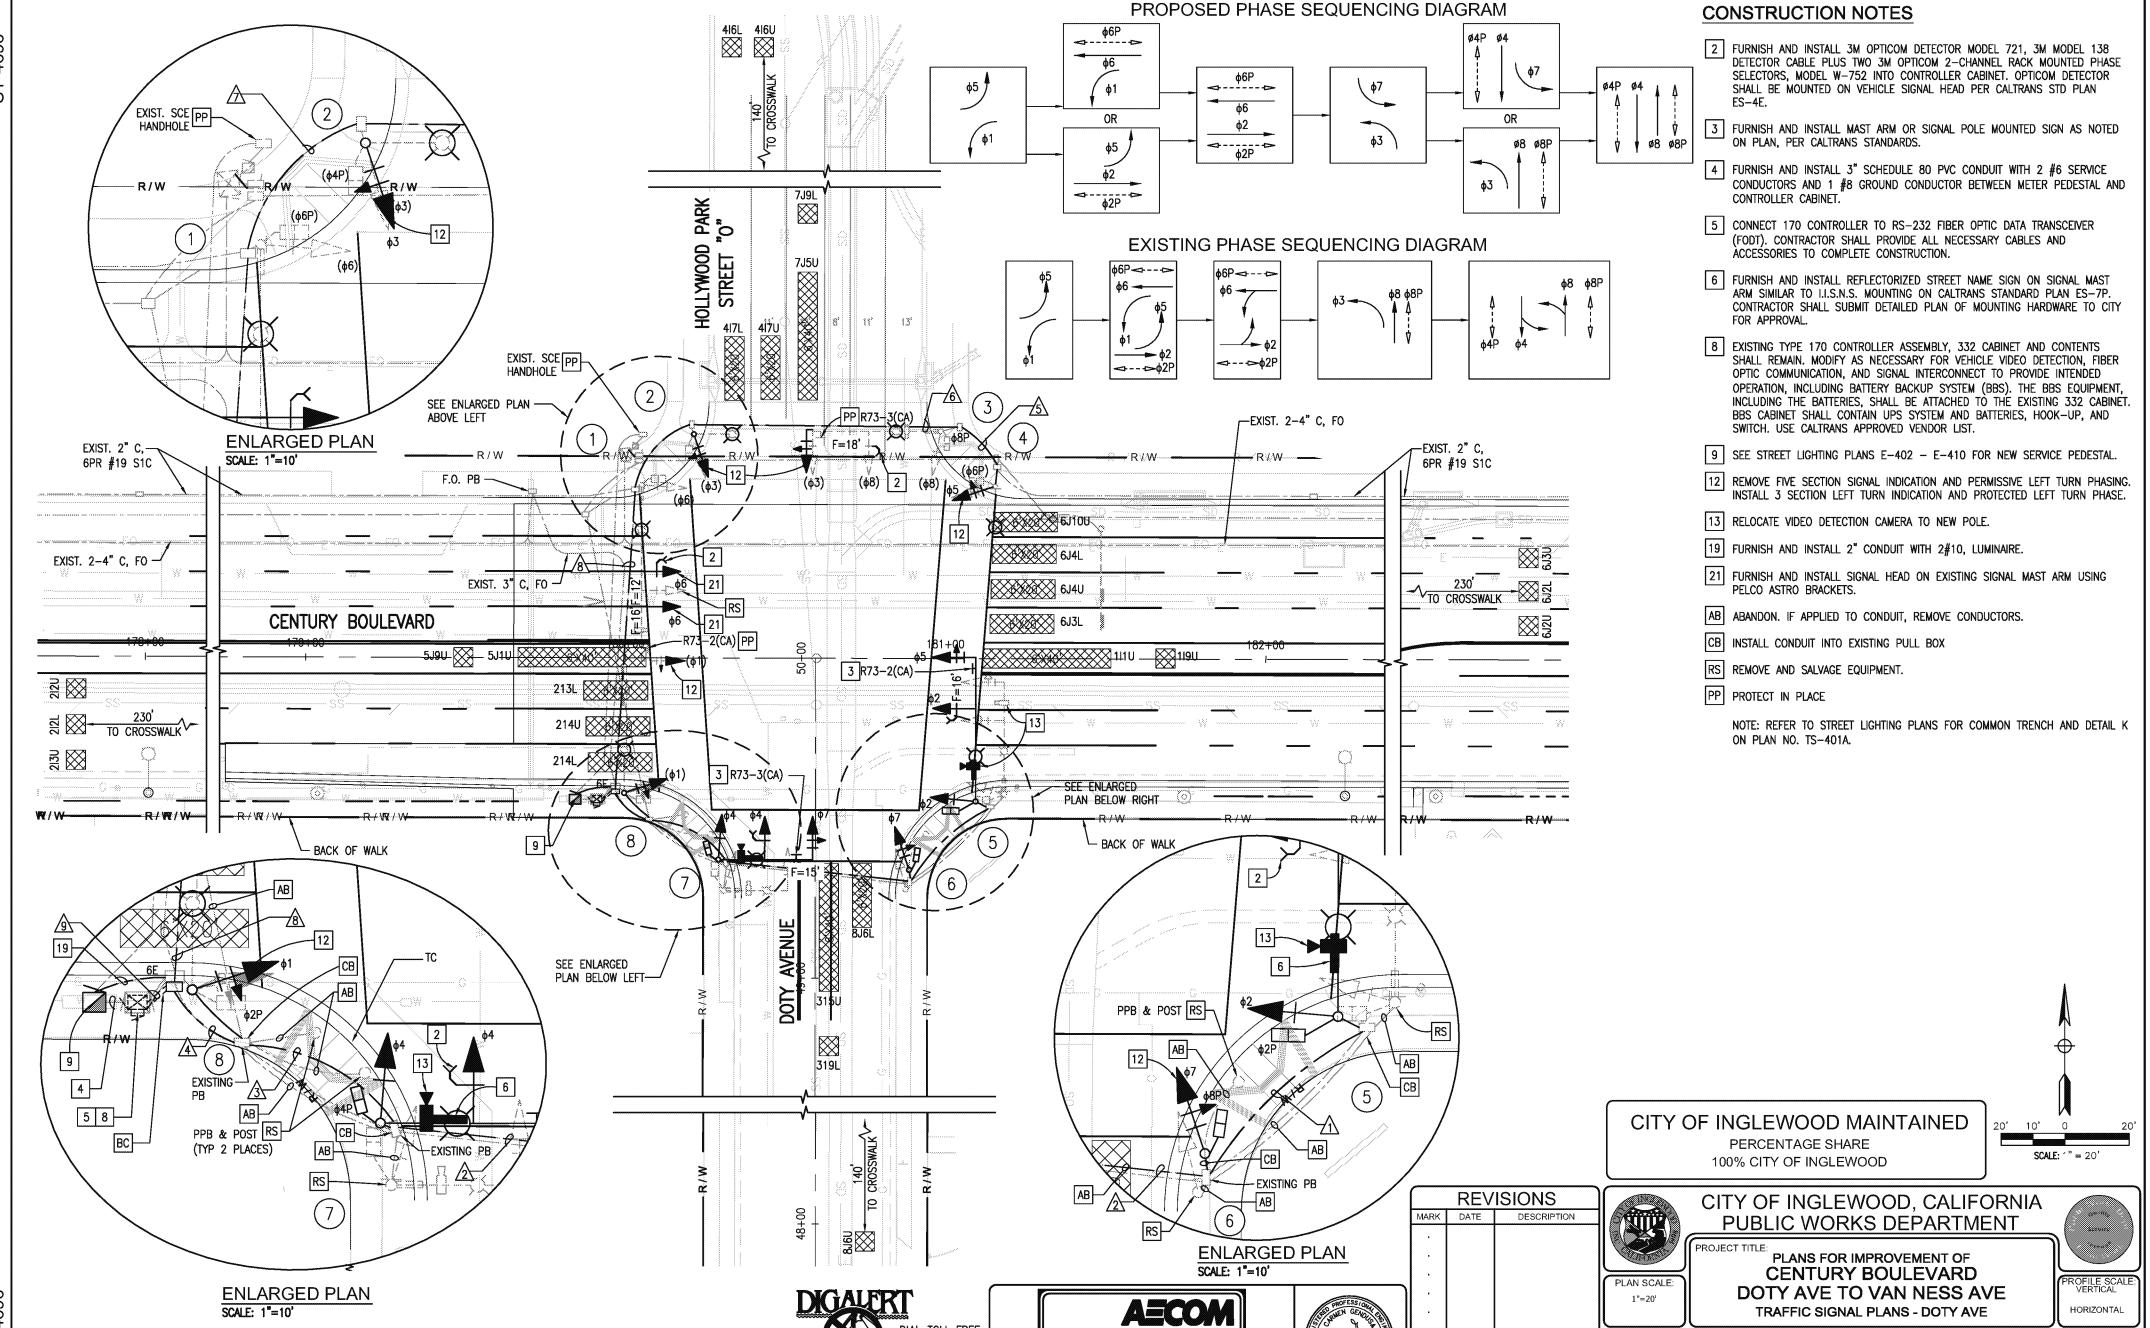
PLANS FOR IMPROVEMENT OF **CENTURY BOULEVARD** DOTY AVE TO VAN NESS AVE

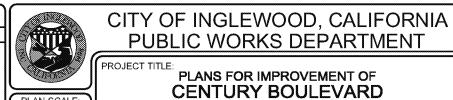TYPICAL WI-FI DETECTION PLAN

5/18/2015

TS-401C SHEET NO. 100 OF 215





AECOM Technical Services, Inc. 515 S. FLOWER ST., 4th FLOOR LOS ANGELES, CA 90071 T 213.330.7200 F 213.330.7201 No. 54987 EXP. 6/30/16

DESIGNED BY:

DIAL TOLL FREE

811

UNDERGROUND SERVICE ALERT OF SOUTHERN CALIFORNIA

696 Drawing Name: W.;6016089 Last Obened: Mav 14, 2015

PLAN NO.

TS-402
SHEET NO.
101 OF 215

5/18/2015

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	POLE AND EQUIPMENT SCHEDULE														
NO.	S	STANDAR			LED LUMINAIRE	R.S.N.S. LEGEND		NAL MOUNT	ING PED	1	USH BUT E DETAIL	` '	POLE LO	CATION TAIL "B"*	REMARKS
NO.	TYPE	HEIGHT	SIGNAL M. A.	LUM. M. A.	(1)	N.S.N.S. ELGEND	M. A.	POLE	(2)	QUAD.	PHASE	ARROW	Α	В	
1	29A-5-100(E)	35'(E)	55'(E)	15'(E)	196W	Doty	3-MAS	SV-1-T(E)	SP-1-T(E)	2(E)	4(E)	→ (E)	EXIS	TING	REPLACE EXISTING 400W HPSV LUMINAIRE.
2	21TS(E)	35'(E)	_	15'(E)	196W	-	-	SV-1-T	SP-1-T(E)	3(E)	6(E)	—— (E)	EXIS	TING	REPLACE EXISTING 400W HPSV LUMINAIRE.
3	26A-4-100(E)	35'(E)	40'(E)	15'(E)	196W	Century	MAS(E) MAS	SV-1-T(E)	SP-1-T(E)	3(E)	6(E)	(E)	EXIS	TING	REPLACE EXISTING 400W HPSV LUMINAIRE.
4	21TS(E)	35'(E)	_	15'(E)	196W	-	-	SV-1-T	SP-1-T(E)	4(E)	8(E)		EXIS	TING	REPLACE EXISTING 400W HPSV LUMINAIRE.
(5)	26A-4-100	35'	45'	12'	196W	Doty (E)	2-MAS	SV-1-T	SP-1-T	4	8		10'	3'	REPLACE EXISTING 400W HPSV LUMINAIRE.
6	1-A	10'	_		_	-	-	TV-1-T	SP-1-T	1	2		9'	3'	REPLACE EXISTING 400W — HPSV LUMINAIRE.
7	19A-4-100	35'	30'	12'	196W	Century (E)	2-MAS	SV-1-T	SP-1-T	1	2		12'	4'	REPLACE EXISTING 400W HPSV LUMINAIRE
8	21TS(E)	35'	_	12'(E)	196W	-	-	SV-1-T	SP-1-T(E)	2(E)	4(E)	—— (E)	0'(E)	2'(E)	REPLACE EXISTING 400W HPSV LUMINAIRE

ALL EQUIPMENT IS NEW UNLESS NOTED OTHERWISE.

(E) = EXISTING. (R) = RELOCATED.

* SEE SHEET TS-401C

(1) EXISTING LUMINAIRE HEADS TO BE UPGRADED TO LED.

(2) LED COUNTDOWN PEDESTRIAN SIGNAL FACE.

Ċ		ACCESSIBLE	PEDESTRIAN	SIGNAL.
١.	"	ACCESSIDEE	FEDESINAN	JIOIME

CONDUCTOR AND CONDUIT SCHEDULE										
AWG SIZE	CONDUIT LOCATION								·	1
OR CABLE TYPE	POLE & PHASES	\triangle	$\sqrt{2}$	$\sqrt{3}$	4	<u>/</u> 5	<u>6</u>	$\sqrt{2}$	8	9
	① - ø1, ø6, ø6P, ø4PPB	-/-	-/-	-/-	-/-	-/-	-/-	-/-	1/1	1/1
12 CABLE	② - ø3, ø4P, ø6PPB	-/-	-/-	-/-	-/-	-/-	-/-	1/1	1/1	1/1
	③ - ø3, ø8, ø8P, ø6PPB	-/-	-/-	-/-	-/-	-/-	1/1	1/1	1/1	1/1
11-#14 1-#12	4 – ø5, ø6P, ø8PPB	-/-	-/-	-/-	-/-	1/1	1/1	1/1	1/1	1/1
	⑤ – ø2, ø5, ø2P, ø8PPB	1/1	1/1	1/1	1/1	-/-	-/-	-/-	-/-	1/1
(3-#14, PPB)	⑥ – Ø7, Ø8P, Ø2PPB	-/-	1/1	1/1	1/1	-/-	-/-	-/-	-/-	1/1
	⑦ - ø4, ø7, ø4P, ø2PPB	-/-	-/-	1/1	1/1	-/-	-/-	-/-	-/-	1/1
CABLE	⊗ − ø1, ø2P, ø4PPB	-/-	-/-	-/-	1/1	-/-	-/-	-/-	-/-	1/1
	TOTALS: 12 CONDUCTOR / 3 CONDUCTOR	1/1	2/2	3/3	4/4	1/1	2/2	3/3	4/4	8/8
#10	LUMINAIRES	2	2	2	2	2	2	2	2	
VIDEO	DETECTION CABLE	1	1	2	2		1	1	2	4
	EV CABLE	1	1	2	2	_	1	1	2	4
	6PR #19 SIC	_		_		1	1	1	2	2
7	72 SMFO CABLE			_		_	_	_	_	1
С	ONDUIT % FILL	13	20	18	22	10	22	16	25	41
	CONDUIT SIZE	3"	3"	4"	4"	3"	3"	4"	4"	2-3" (E)


ALL CONDUCTORS CABLES AND CONDUITS ARE NEW UNLESS NOTED OTHERWISE.

(E) = EXISTING







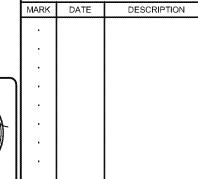

REVISIONS

CITY OF INGLEWOOD, CALIFORNIA PUBLIC WORKS DEPARTMENT

PLANS FOR IMPROVEMENT OF CENTURY BOULEVARD DOTY AVE TO VAN NESS AVE TRAFFIC SIGNAL PLANS - DOTY AVE


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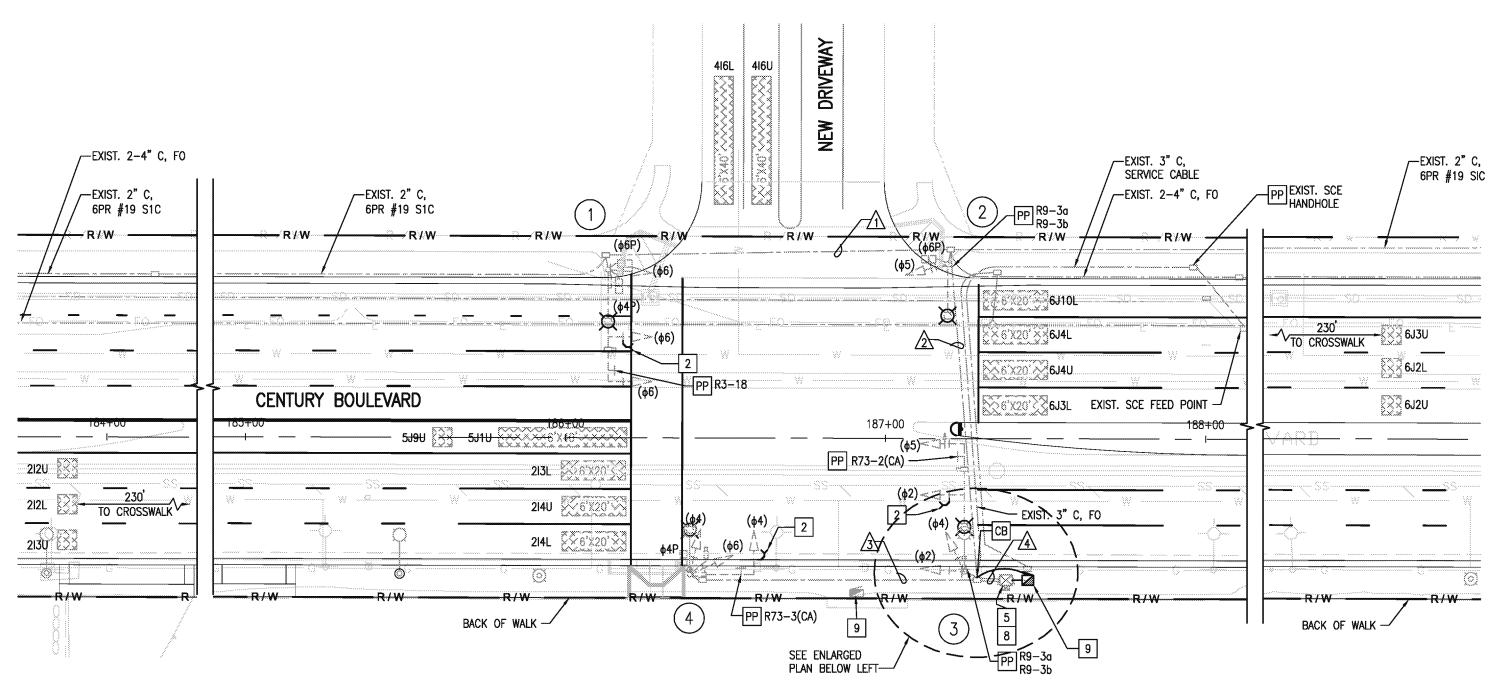
PERCENTAGE SHARE 100% CITY OF INGLEWOOD

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UNDERGROUND SERVICE ALERT OF SOUTHERN CALIFORNIA

EXISTING PHASE SEQUENCING DIAGRAM




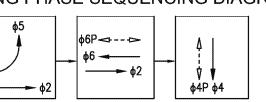

CONSTRUCTION NOTES

- 2 FURNISH AND INSTALL 3M OPTICOM DETECTOR MODEL 721, 3M MODEL 138 DETECTOR CABLE PLUS TWO 3M OPTICOM 2-CHANNEL RACK MOUNTED PHASE SELECTORS, MODEL W-752 INTO CONTROLLER CABINET, OPTICOM DETECTOR SHALL BE MOUNTED ON VEHICLE SIGNAL HEAD PER CALTRANS STD PLAN
- 4 FURNISH AND INSTALL 3" SCHEDULE 80 PVC CONDUIT WITH 2 #6 SERVICE CONDUCTORS AND 1 #8 GROUND CONDUCTOR BETWEEN METER PEDESTAL AND CONTROLLER CABINET."
- 5 CONNECT 2070L CONTROLLER TO RS-232 FIBER OPTIC DATA TRANSCEIVER (FODT). CONTRACTOR SHALL PROVIDE ALL NECESSARY CABLES AND ACCESSORIES TO COMPLETE CONSTRUCTION.
- 8 EXISTING TYPE 2070 CONTROLLER ASSEMBLY, 332 CABINET AND CONTENTS SHALL REMAIN. MODIFY AS NECESSARY FOR VEHICLE VIDEO DETECTION, FIBER OPTIC COMMUNICATION, AND SIGNAL INTERCONNECT TO PROVIDE INTENDED OPERATION, INCLUDING BATTERY BACKUP SYSTEM (BBS). THE BBS EQUIPMENT, INCLUDING THE BATTERIES, SHALL BE ATTACHED TO THE EXISTING 332 CABINET. BBS CABINET SHALL CONTAIN UPS SYSTEM AND BATTERIES, HOOK-UP, AND SWITCH. USE CALTRANS APPROVED VENDOR LIST.
- 9 SEE STREET LIGHTING PLANS E-402 E-410 FOR NEW SERVICE PEDESTAL, AND E-413 FOR STREET LIGHTING FOR TRAFFIC SIGNAL LUMINAIRES.
- 19 FURNISH AND INSTALL 2" CONDUIT WITH 2#10, LUMINAIRE.
- PP PROTECT IN PLACE


NOTE: REFER TO STREET LIGHTING PLANS FOR COMMON TRENCH AND DETAIL K ON PLAN NO. TS-401A.

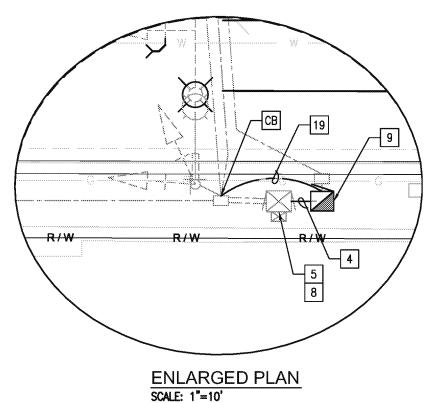

DIAL TOLL FREE 811 UNDERGROUND SERVICE ALERT OF SOUTHERN CALIFORNIA





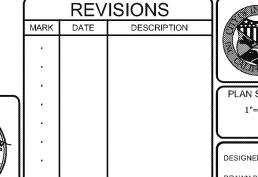




PUBLIC WORKS DEPARTMENT PLANS FOR IMPROVEMENT OF CENTURY BOULEVARD

CITY OF INGLEWOOD MAINTAINED PERCENTAGE SHARE

100% CITY OF INGLEWOOD

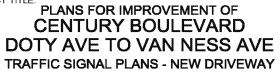

CITY OF INGLEWOOD, CALIFORNIA



SCALE: '" = 20'

TS-403 5/18/2015 SHEET NO. 103 OF 215

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	POLE AND EQUIPMENT SCHEDULE														
	:	STANDAR	D		LED			NAL MOUNT		1	JSH BUT DETAIL	` ' '	POLE LO		REMARKS REPLACE EXISTING 250 HPSV LUMINAIRE
NO.	TYPE	HEIGHT	SIGNAL M. A.	LUM. M. A.	LUMINAIRE (1)	R.S.N.S LEGEND	M. A.	ICLE POLE	PED (2)	 		ARROW		В	REMARKS
1	24A-4-100	35'	35'	15'	196W(N)	Hollywood Park	2-MAS	SV-1-T	SP-1-T SP-1-T	1 2	4 6		EXIS	TING	
2	21	35'	_	15'	196W(N)	-	-	SV-1-T	SP-1-T	1	6		EXIS	TING	REPLACE EXISTING 250 HPSV LUMINAIRE
3	26A-4-100	35'	45'	15'	196W(N)	Hollywood Park	2-MAS	SV-2-T	_	_	_	-	EXISTING		REPLACE EXISTING 250 HPSV LUMINAIRE
4	17–3–100	30'	20'	12'	196W(N)	Century **	MAS	SV-1-T	SP-1-T	4	4		EXIS	TING	REPLACE EXISTING 250 HPSV LUMINAIRE

** = SINGLE FACE S.N.S. FACING NORTH.
ALL EQUIPMENT IS EXISTING UNLESS NOTED OTHERWISE.
(N) = NEW EQUIPMENT

* SEE SHEET TS-401C

(1) EXISTING LUMINAIRE HEADS TO BE UPGRADED TO LED.

(2) LED COUNTDOWN PEDESTRIAN SIGNAL FACE.

(3) ACCESSIBLE PEDESTRIAN SIGNAL.

CONDUCTOR AND CONDUIT SCHEDULE							
AWG SIZE OR	POLE & PHASES A I A I				TION		
CABLE TYPE		$ 2\rangle$	<u> </u>	<u> </u>	<u> </u>		
12 CABLE	①ø6 / ø4PPB, ø6PPB	1/2	1/2		1/2		
. /	② Ø5 / Ø6PPB		1/1		1/1		
11-#14 1-#12	③ ø2,ø4,ø5				2/-		
(3-#14,PPB)	④ ø4,ø6 / ø4PPB			1/1	1/1		
CABLE	TOTALS 12 CONDUCTOR / 3 CONDUCTOR	1/2	2/3	1/1	5/4		
#10	LUMINAIRES	2	2	2	-		
VIDEO D	ETECTION CABLE	1	1	1	3		
	EV CABLE	1	2	1	3		
61	PR #19 SIC	1	2	_	2		
72	SMFO CABLE	_	_	_	1		
CON	IDUIT % FILL	17	28	13	28		
CON	DUIT SIZE	3"	3"	3"	2-3"		

ALL CONDUCTORS CABLES AND CONDUITS ARE EXISTING UNLESS NOTED OTHERWISE.








	MARK	DATE	DESCRIPTION	
				PLAN
				PLAN
٠				\geq
				DESIGN
				DRAWN
				CHECK

CITY OF INGLEWOOD, CALIFORNIA PUBLIC WORKS DEPARTMENT

PLANS FOR IMPROVEMENT OF CENTURY BOULEVARD DOTY AVE TO VAN NESS AVE TRAFFIC SIGNAL PLANS - NEW DRIVEWAY

TS-403A 5/18/2015 SHEET NO. 104 OF 215

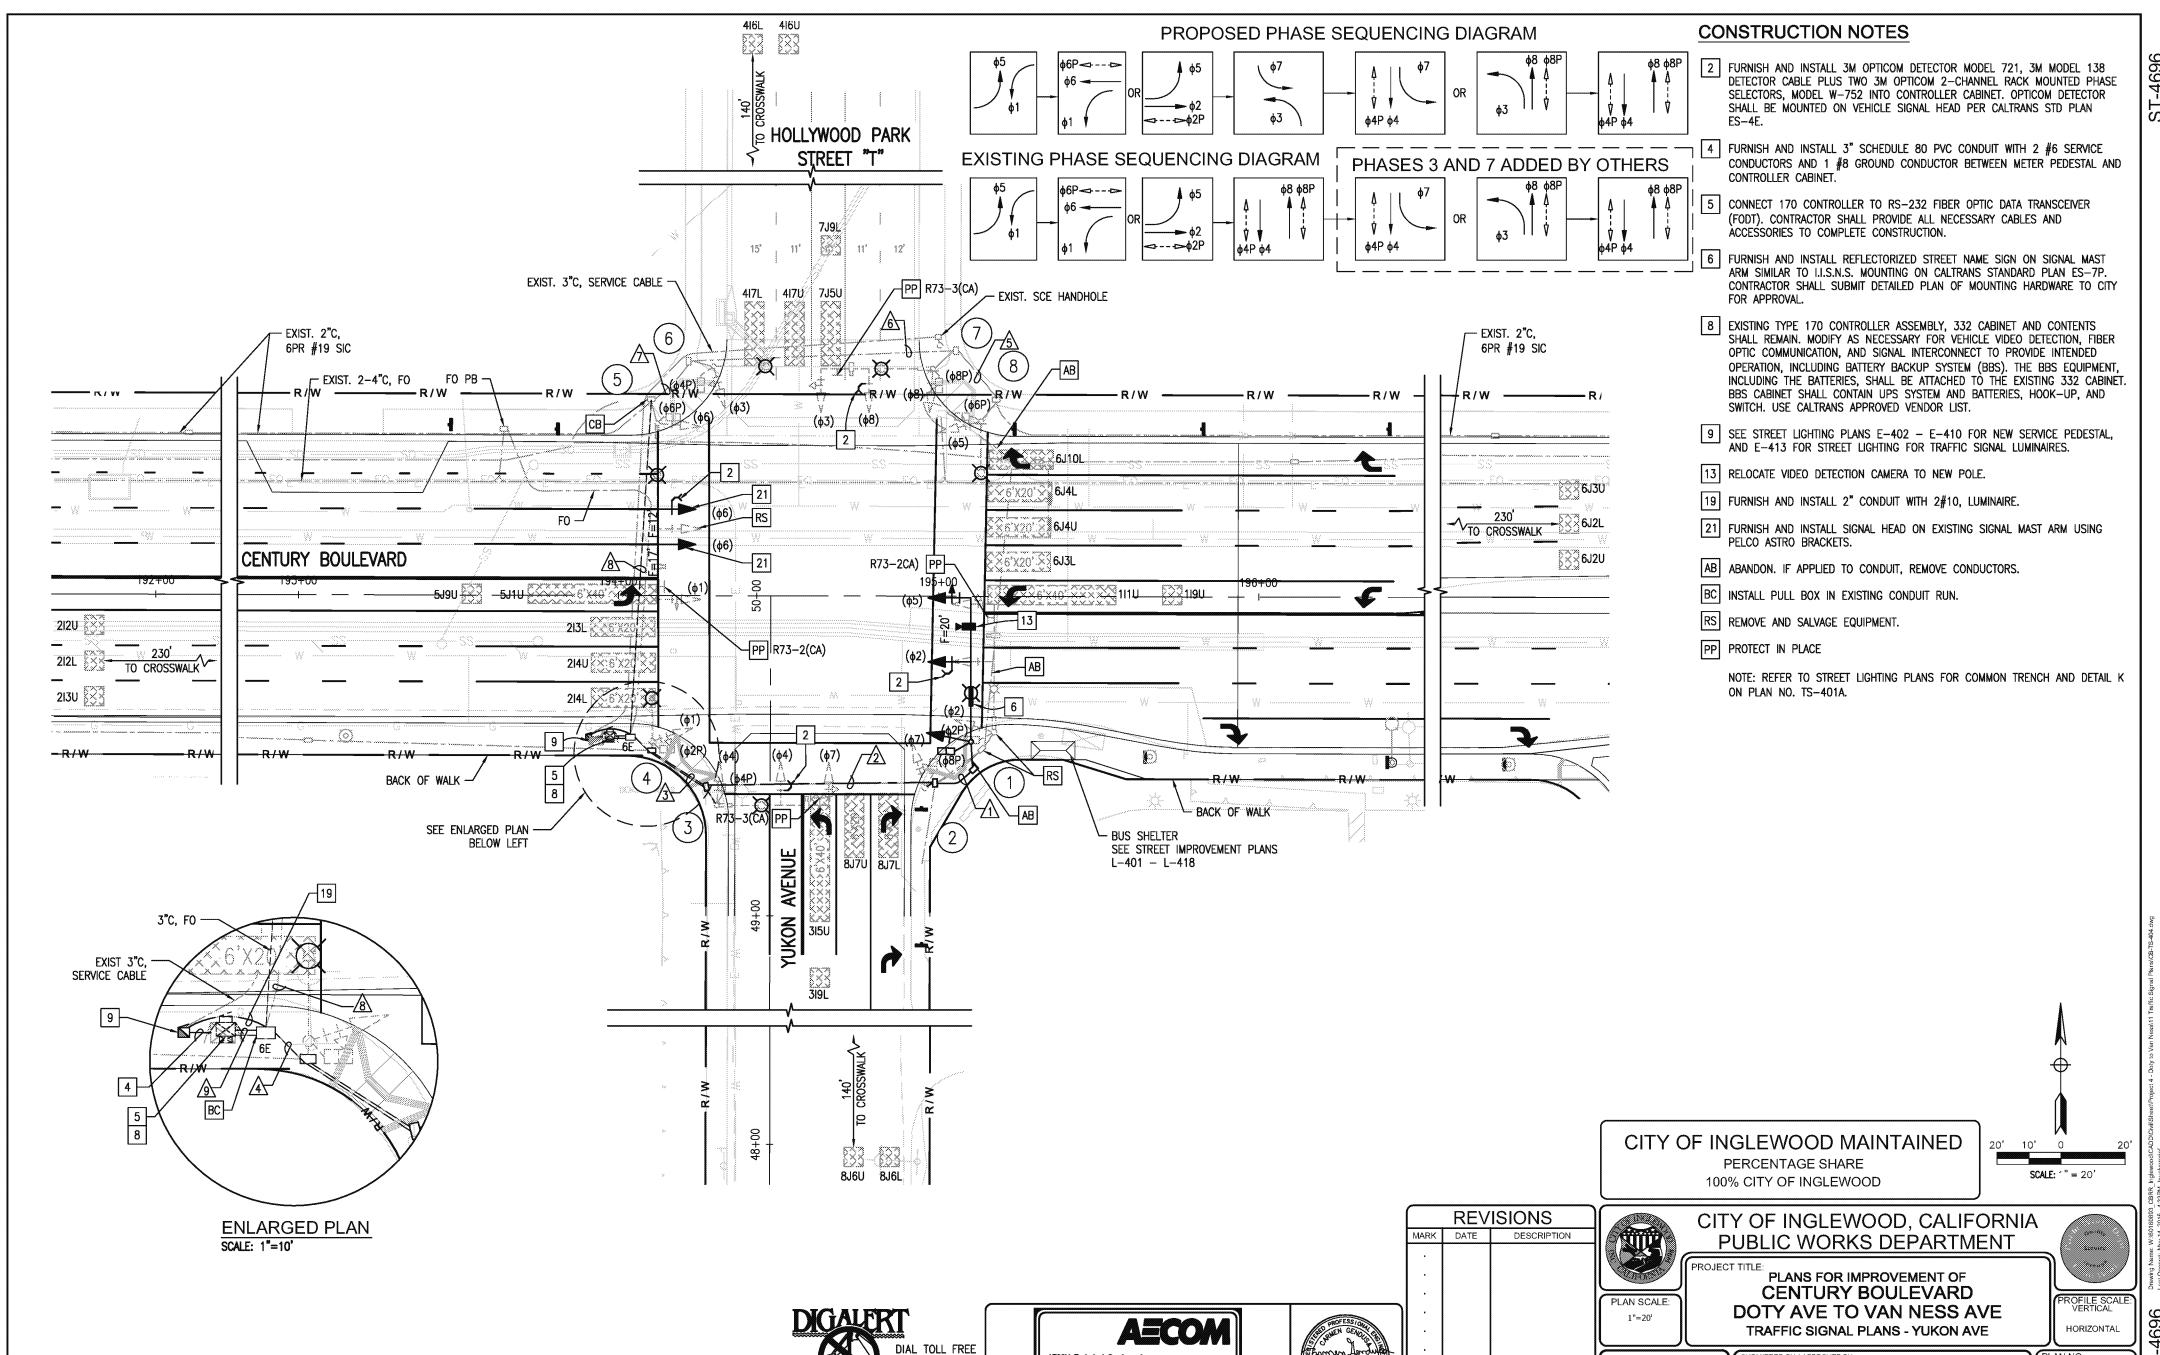

AECOM Technical Services, Inc. 515 S. FLONER ST., 4th FLOOR LOS ANGELES, CA 90071 T 213.330.7200 F 213.330.7201

811

UNDERGROUND SERVICE ALERT OF SOUTHERN CALIFORNIA

TS-404

SHEET NO. 105 OF 215

5/18/2015

ST-4696

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	POLE AND EQUIPMENT SCHEDULE														
N.		STANDARD		r	LED LUMINAIRE	R.S.N.S. LEGEND		IGNAL MOUNTIN		PED PU	JSH BUTT SEE DETAIL'	ONS (3)	POLE LO		DENADIVO
No.	Туре	Height	Sig. M.a.	Lum. M.a.	(1)	K.S.N.S. LEGEND	M.A.	HICLE POLE	PED (2)	QUAD.	PHASE	ARROW	A	В	REMARKS
1	26A-4-100(N)	35'(N)	45'(N)	12'(N)	196W (N)	Yukon	2 MAS(N)	SV-1-T(N)	SP-1-T(N)	4(N)	ø8(N)	—(N)	11.3'	3	RS POLE COMPLETE; RELOCATE VIDEO CAMERA TO NEW POLE
2	1-A	10'	_	-				TV-1-T	SP-1-T	1	ø2		EXIS	TING	
3	24A-4-100	35'	35'	15'	196W (N)	Century	2 MAS	SV-1-T	SP-1-T	1	ø2		EXIS	TING	RS 250W LUMINAIRE
4	TYPE 21	35'		12'	196W (N)			SV-1-T	SP-1-T	3	ø 4		EXIS	TING	RS 250W LUMINAIRE
5	29A-5-100	35'	55'	15'	196W (N)	Yukon	2 MAS(N) MAS	SV-1-T	SP-1-T	3	ø 4		EXIS	TING	RS 250W LUMINAIRE
6	TYPE 21	35'		15'	196W (N)			SV-1-T	SP-1-T	5	ø6		EXIS	TING	RS 250W LUMINAIRE
7	24A-4-100	35'	35'	15'	196W (N)	Century	MAS MAS	SV-1-T	SP-1-T	5	ø6		EXIS	TING	RS 250W LUMINAIRE
8	TYPE 21	35'	_	15'	196W (N)		-	SV-1-T	SP-1-T	7	ø8		EXIS	TING	RS 250W LUMINAIRE

ALL EQUIPMENT IS EXISTING UNLESS NOTED OTHERWISE.

(N) = NEW

* SEE SHEET TS-401C

(1) EXISTING LUMINAIRE HEADS TO BE UPGRADED TO LED.

(2) LED COUNTDOWN PEDESTRIAN SIGNAL FACE.

(3) ACCESSIBLE PEDESTRIAN SIGNAL.

CONDUCTOR AND CONDUIT SCHEDULE											
AWG SIZE OR	POLE & PHASES	CONDUIT LOCATION									
CABLE TYPE	FOLL & FINAGES		<u>/2\</u>	<u>/3\</u>	4	<u>/5\</u>	<u>/6\</u>	<u>/</u>	8	9	
12 /	① Ø2,Ø5,Ø2P / Ø8PPB	1/1	1/1	1/1	1/1					1/1	
CABLE /	② ø7,ø8P / ø2PPB		1/1	1/1	1/1					1/1	
11-#14	③ ø4,ø7,ø4P / ø2PPB			1/1	1/1					1/1	
1-#12	4 ø1,ø2P / ø4PPB				1/1					1/1	
/	(5) Ø1,Ø6,Ø6P / Ø4PPB								1/1	1/1	
/	⑥ ø3,ø4P / ø6PPB							1/1	1/1	1/1	
(3-#14,PPB)	⑦ Ø8,Ø3,Ø8P / Ø6PPB						1/1	1/1	1/1	1/1	
3	8 ø5,ø6P / ø8PPB					1/1	1/1	1/1	1/1	1/1	
CABLE	TOTALS 12 CONDUCTOR / 3 CONDUCTOR	1/1	2/2	3/3	4/4	1/1	2/2	3/3	4/4	8/8	
#10	LUMINAIRES	2	2	2	2	2	2	2	2	-	
VIDEO DETECTION CABLE			1	2	2	1	1	1	2	4	
	1	1	2	2	-	1	1	2	4		
6	_	_	_	-	1	1	1	2	2		
72	_		_	_	_	_	-	_	1		
CONDUIT % FILL			20	31	22	10	22	28	25	41	
CONDUIT SIZE			3"(E)	3"(E)	4"	3"(E)	3"(E)	3"(E)	4"	2-3" (E)	


ALL CONDUCTORS CABLES AND CONDUITS ARE NEW UNLESS NOTED OTHERWISE. PHASES 3 AND 7 ADDED BY OTHERS.

(E) = EXISTING

DIAL TOLL FREE 811 UNDERGROUND SERVICE ALERT OF SOUTHERN CALIFORNIA





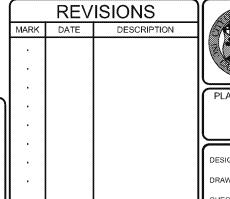

CITY OF INGLEWOOD, CALIFORNIA PUBLIC WORKS DEPARTMENT


PLANS FOR IMPROVEMENT OF CENTURY BOULEVARD DOTY AVE TO VAN NESS AVE TRAFFIC SIGNAL PLANS - YUKON AVE

PERCENTAGE SHARE 100% CITY OF INGLEWOOD

> HORIZONTAL 5/18/2015 DATE


TS-404A SHEET NO. 106 OF 215



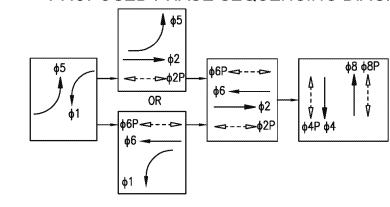

EXISTING PHASE SEQUENCING DIAGRAM

PROPOSED PHASE SEQUENCING DIAGRAM

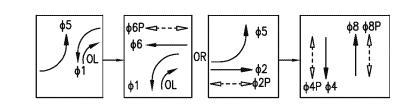

INSTALL BUS SHELTER PER OMNITRANS BUS STOP DESIGN

CENTURY BOULEVARD

GUIDELINES.

- BACK OF WALK

CONSTRUCTION NOTES

- 2 FURNISH AND INSTALL 3M OPTICOM DETECTOR MODEL 721, 3M MODEL 138 DETECTOR CABLE PLUS TWO 3M OPTICOM 2-CHANNEL RACK MOUNTED PHASE SELECTORS, MODEL W-752 INTO CONTROLLER CABINET, OPTICOM DETECTOR SHALL BE MOUNTED ON VEHICLE SIGNAL HEAD PER CALTRANS STD PLAN
- 3 FURNISH AND INSTALL MAST ARM OR SIGNAL POLE MOUNTED SIGN AS NOTED ON PLAN, PER CALTRANS STANDARDS.
- 4 FURNISH AND INSTALL 3" SCHEDULE 80 PVC CONDUIT WITH 2 #6 SERVICE CONDUCTORS AND 1 #8 GROUND CONDUCTOR BETWEEN METER PEDESTAL AND
- 5 CONNECT 170 CONTROLLER TO RS-232 FIBER OPTIC DATA TRANSCEIVER (FODT). CONTRACTOR SHALL PROVIDE ALL NECESSARY CABLES AND ACCESSORIES TO COMPLETE CONSTRUCTION.
- FURNISH AND INSTALL REFLECTORIZED STREET NAME SIGN ON SIGNAL MAST ARM SIMILAR TO I.I.S.N.S. MOUNTING ON CALTRANS STANDARD PLAN ES-7P. CONTRACTOR SHALL SUBMIT DETAILED PLAN OF MOUNTING HARDWARE TO CITY FOR APPROVAL.
- 8 EXISTING TYPE 170 CONTROLLER ASSEMBLY, 332 CABINET AND CONTENTS SHALL REMAIN. MODIFY AS NECESSARY FOR VEHICLE VIDEO DETECTION, FIBER OPTIC COMMUNICATION, AND SIGNAL INTERCONNECT TO PROVIDE INTENDED OPERATION, INCLUDING BATTERY BACKUP SYSTEM (BBS). THE BBS EQUIPMENT, INCLUDING THE BATTERIES, SHALL BE ATTACHED TO THE EXISTING 332 CABINET. BBS CABINET SHALL CONTAIN UPS SYSTEM AND BATTERIES, HOOK-UP, AND SWITCH. USE CALTRANS APPROVED VENDOR LIST.
- 9 SEE STREET LIGHTING PLANS E-402 E-410 FOR NEW SERVICE PEDESTAL, AND E-413 FOR STREET LIGHTING FOR TRAFFIC SIGNAL LUMINAIRES.
- 10 INSTALL VIDEO DETECTION CAMERA PER SPECIFICATIONS.
- 14 FURNISH AND ATTACH "PIGGY BACK" BATTERY CABINET AND SYSTEM (BBS) TO EXISTING CONTROLLER CABINET.
- 19 FURNISH AND INSTALL 2" CONDUIT WITH 2#10, LUMINAIRE.
- 20 FURNISH AND INSTALL 3" CONDUIT BETWEEN SERVICE ENCLOSURE AND SERVICE POINT PER SCE REQUIREMENTS.
- AB ABANDON. IF APPLIED TO CONDUIT, REMOVE CONDUCTORS.
- BC INSTALL PULL BOX IN EXISTING CONDUIT RUN.
- PP PROTECT IN PLACE.

₩ 6J3W

₩ 6J2L

₩ 6J2U

205+00


CROSSWALK

- RC EQUIPMENT OR MATERIAL TO BE REMOVED AND BECOME THE PROPERTY OF THE CONTRACTOR.
- RS REMOVE AND SALVAGE EQUIPMENT.


1. REFER TO STREET LIGHTING PLANS FOR COMMON TRENCH AND DETAIL K

2. ALL EXISTING CONDUITS NOT SHOWN FOR REUSE SHALL BE ABANDONED.

- ON PLAN NO. TS-401A.
- 3. ALL EXISTING PULLBOXES NOT SHOWN FOR REUSE SHALL BE REMOVED AND BECOME THE PROPERTY OF THE CONTRACTOR

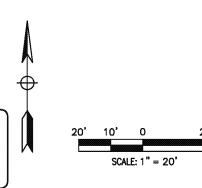

CITY OF INGLEWOOD MAINTAINED PERCENTAGE SHARE 100% CITY OF INGLEWOOD

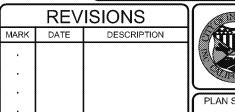

CITY OF INGLEWOOD, CALIFORNIA PUBLIC WORKS DEPARTMENT

PLANS FOR IMPROVEMENT OF **CENTURY BOULEVARD** DOTY AVE TO VAN NESS AVE TRAFFIC SIGNAL PLANS - CLUB DRIVE

TS-405 5/18/2015 SHEET NO. 107 OF 215

DIAL TOLL FREE 811 UNDERGROUND SERVICE ALERT OF SOUTHERN CALIFORNIA

- SEE ENLARGED PLAN

3 R73-3(CA) -

ABOVE LEFT

202+00

UB DRIV

3 R3-4 ¬



- BACK OF WALK



6J3L

- R / VR / V

EXIST. 2-4" FO

BACK OF WALK

#6E PB

ENLARGED PLAN

BACK OF WALK -

-5J9U 5J1U

BACK OF WALK

INSTALL BUS SHELTER PER OMNITRANS BUS STOP DESIGN

GUIDELINES.

213L

2I4U **(3)**

EXIST. SCE

SERVICE VAULT

SCALE: 1"=10"

HANDHOLE

20 BBS 14

EXIST. 2" C, -6PR #19 SIC

EXIST. 2-4", FO -

RAWW-

CROSSWALK

RAVV

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~T
- 4
-
<i></i>
V ,

	POLE AND EQUIPMENT SCHEDULE															
		STANDAR	:D		LED			NAL MOUNT			ISH BUTT E DETAIL		POLE LO	OCATION TAIL "B"*		
NO.	TYPE	HEIGHT	SIGNAL M. A.	LUM. M. A.	LUMINAIRE	R.S.N.S LEGEND	M. A.	POLE	PED (1)	QUAD.	PHASE	ARROW	А	В		REMARKS
0	26-4-100	30'	45'	12'	196W	Club Dr	2-MAS	SV-1-T	SP-1-T	2	4	-	.5'	3'	_	
2	1-A	10'	_	_	-	-	-	TV-2-T	SP-1-T	3	6		4.8'	3'	_	
3	19-4-100	30'	25'	12'	196W	Century	MAS	SV-1-T	SP-1-T	3	6		4.8'	3'	_	
4	15TS	30'	_	12'	196W	-	_	SV-1-T	SP-1-T	4	8	is a	4.8'	3'	_	
(5)	26-4-100	30'	45'	12'	196W	Club Dr	2-MAS	SV-1-T	SP-1-T	4	8		2.5'	6.5'	_	
6	1-A	10'	_	_	_	-	_	TV-2-T	SP-1-T	1	2		4.8'	3'	_	
7	19-4-100	30'	25'	12'	196W	Century	MAS	SV-1-T	SP-1-T	1	2		4.5'	3'	_	
8	15TS	30'	_	12'	196W	-	-	SV-1-T	SP-1-T	2	4		4.8'	3'	_	

ALL SIGNAL EQUIPMENT IS NEW UNLESS NOTED OTHERWISE.

* SEE SHEET TS-401C

(1) LED COUNTDOWN PEDESTRIAN SIGNAL FACE.(2) ACCESSIBLE PEDESTRIAN SIGNAL.

CONDUCTOR AND CONDUIT SCHEDULE										
AWG SIZE				CON	IDUIT	LOCA	TION			
OR CABLE TYPE	POLE & PHASES	Λ	<u></u>	<u></u>	4	<u>/</u> 5	6	/7	8	9
	① - Ø1, Ø6, Ø6P, Ø4PPB	-/-	-/-	-/-	-/-	-/-	-/-	-/-	1/1	1/1
12 CABLE	② - ø4, ø8, ø4P, ø6PPB	-/-	-/-	1/1	-/-	-/-	-/-	-/-	1/1	1/1
	③ - Ø8, Ø8P, Ø6PPB	-/-	1/1	1/1	-/-	-/-	-/-	-/-	1/1	1/1
11-#14 1-#12	④ − ø5, ø6P, ø8PPB	1/1	1/1	1/1	-/-	-/-	-/-	-/-	1/1	1/1
	⑤ – ø2, ø5, ø2P, ø8PPB	-/-	-/-	-/-	1/1	1/1	1/1	1/1	1/1	1/1
(3-#14, PPB)	6 – ø4, ø8, ø8P, ø2PPB	-/-	-/-	-/-	-/-	1/1	1/1	1/1	1/1	1/1
	⑦ - ø4, ø4P, ø2PPB	-/-	-/-	-/-	-/-	-/-	1/1	1/1	1/1	1/1
3 CABLE	8 - ø1, ø2P, ø4PPB	-/-	-/-	-/-	-/-	-/-	-/-	1/1	1/1	1/1
<u>/</u>	TOTALS: 12 CONDUCTOR / 3 CONDUCTOR	1/1	2/2	3/3	1/1	2/2	3/3	4/4	8/8	8/8
#10	LUMINAIRES	2	2	2	2	2	2	2	2	-
VIDEO	DETECTION CABLE	_	1	1	1	1	2	2	4	4
	_	1	1	1	1	2	2	4	4	
6	_	_	_	_		_	_	_	2	
7.	-		-	_		_	-		1	
C	8	20	26	13	20	18	22	21	40	
	3"	3"	3"	3"	3"	4"	4"	2-4"	2-3" (E)	


ALL CONDUCTORS CABLES AND CONDUITS ARE NEW UNLESS NOTED OTHERWISE.
(E) = EXISTING


CITY OF INGLEWOOD MAINTAINED

PERCENTAGE SHARE 100% CITY OF INGLEWOOD

		•
AECOM	PROFESSION GENOTOR	
AECOM Technical Services, Inc. 515 S. FLOMER ST., 4th FLOOR LOS ANGELES, CA 90071 T 213.330,7200 F 213.330,7201 www.secom.com	EXP. 6/30/16	



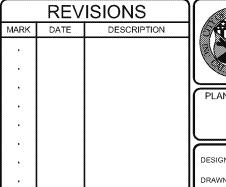

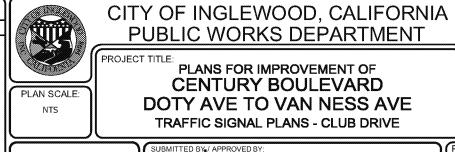


PUBLIC WORKS DEPARTMENT PLANS FOR IMPROVEMENT OF CENTURY BOULEVARD

DOTY AVE TO VAN NESS AVE TRAFFIC SIGNAL PLANS - CLUB DRIVE

5/18/2015 SHEET NO. 108 OF 215

TS-405A

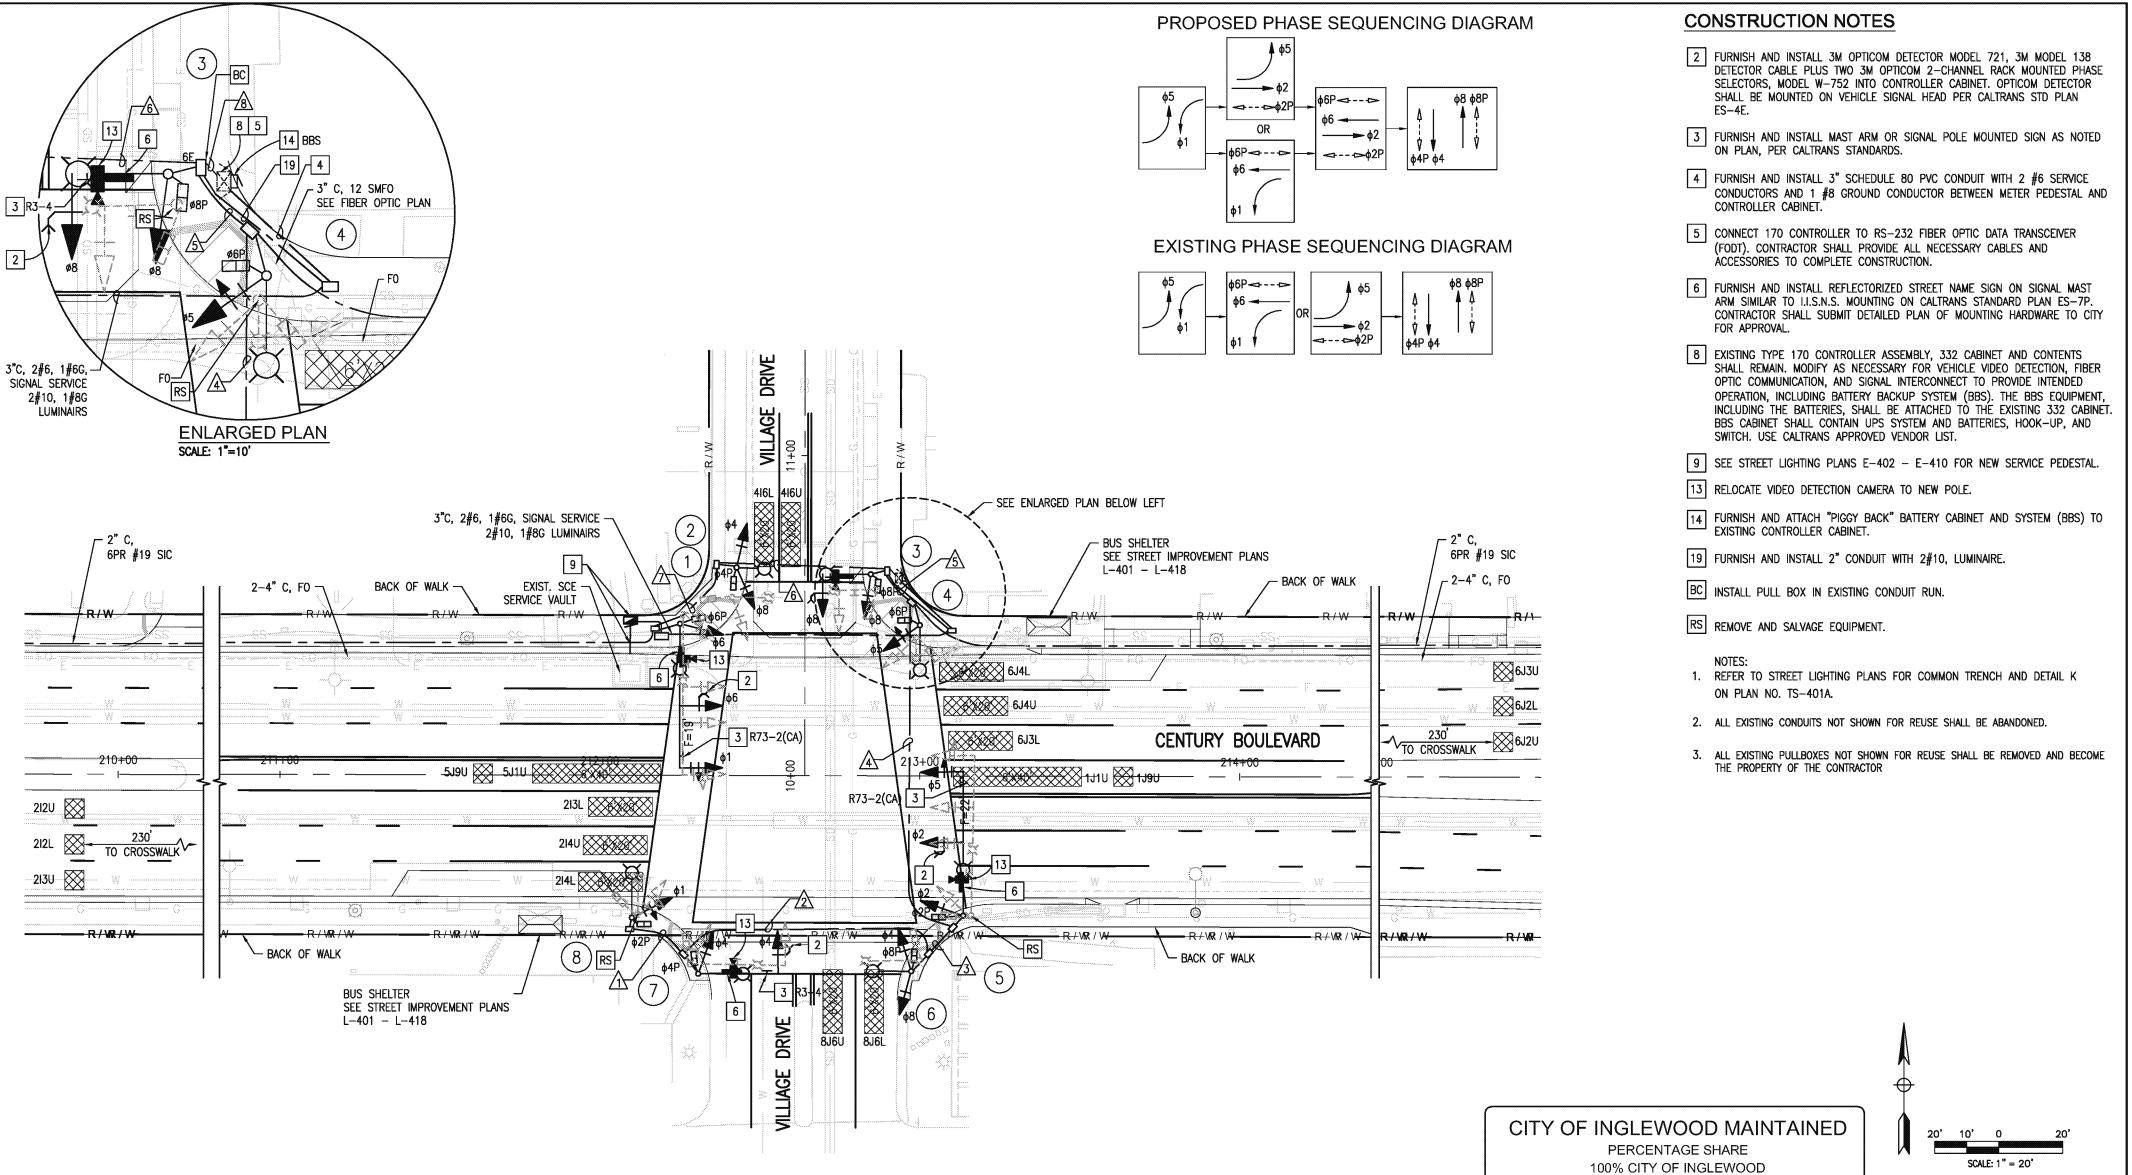

DIAL TOLL FREE

811

UNDERGROUND SERVICE ALERT OF SOUTHERN CALIFORNIA

ST-4696

AECOM

ABOUT Totaled Services, Inc.

SIS S. P. COMP.

ABOUT TO VAN NESS AVE
TRAFFIC SIGNAL PLANS - VILLAGE DRIVE

DESIGNED BY:

DRAWN BY:

DRAW

REVISIONS

MARK DATE DESCRIPTION

ROFILE SCALE: VERTICAL HORIZONTAL INO.
TS-406

CITY OF INGLEWOOD, CALIFORNIA

PUBLIC WORKS DEPARTMENT

TS-406
SHEET NO.
109 OF 215

_E										
	ISH BUTT DETAIL		POLE LO	CATION TAIL "B"*		REMARKS				
UAD.	PHASE	ARROW	Α	В	TEMAKKS					
2	4		4'	7'	_					
3	6	ito	0,	3'	_					
3	6		2'	5'	_					
4	8		7'	6'	_					
4	8		9'	2'	_					
1	2	ita-	10'	3'	_					
1	2		R,	۲,	_					

3'

POLE AND EQUIPMENT SCHEDULE

VEHICLE

2-MAS

MAS

2-MAS

MAS

R.S.N.S LEGEND

Village Dr

Century

Village Dr

Century

SIGNAL MOUNTING

POLE

SV-1-T

SV-1-T

SV-1-T

SV-2-T

SV-1-T

(1)

SP-1-T

SP-1-T

SP-1-T

SP-1-T

SP-1-T

SV-1-T SP-1-T

SV-2-T SP-1-T

SV-1-T SP-1-T

QUAD. PHASE

3

3

4

2

2

4

ALL EQUIPMENT IS NEW UNLESS NOTED OTHERWISE.

STANDARD

30'

30'

30'

30'

HEIGHT SIGNAL LUM. LUMINAIRE M. A. M. A.

12'

10'

12'

12'

12'

10'

12'

12'

196W

196W

196W

196W

196W

196W

196W

45'

15'

45'

25'

* SEE SHEET TS-401C

26-4-100

17-3-100

26-4-100

19-4-100

15TS

3

⑤

7

(1) LED COUNTDOWN PEDESTRIAN SIGNAL FACE.

(2) ACCESSIBLE PEDESTRIAN SIGNAL.

CONDUCTOR AND CONDUIT SCHEDULE									
AWG SIZE				CON	IDUIT	LOCA	TION		
OR CABLE TYPE	POLE & PHASES	Λ	2	$\sqrt{3}$	4	5	6	\overline{A}	8
/	① - ø1, ø6, ø6P, ø4PPB	-/-	-/-	-/-	-/-	-/-	1/1	1/1	1/1
12 CABLE	② - ø4, ø8, ø4P, ø6PPB	-/-	-/-	-/-	-/-	-/-	1/1	-/-	1/1
	③ - Ø8, Ø8P, Ø6PPB	-/-	-/-	-/-	-/-	-/-	-/-	-/-	1/1
11-#14 1-#12	④ − ø5, ø6P, ø8PPB	-/-	-/-	-/-	-/-	1/1	-/-	-/-	1/1
	⑤ – ø2, ø5, ø2P, ø8PPB	-/-	-/-	-/-	1/1	1/1	-/-	-/-	1/1
(3-#14, PPB)	6 - ø4, ø8, ø8P, ø2PPB	-/-	-/-	1/1	1/1	1/1	-/-	-/-	1/1
/	⑦ - ø4, ø4P, ø2PPB	-/-	1/1	1/1	1/1	1/1	-/-	-/-	1/1
3 CABLE	⊗ − ø1, ø2P, ø4PPB	1/1	1/1	1/1	1/1	1/1	-/-	-/-	1/1
	TOTALS: 12 CONDUCTOR / 3 CONDUCTOR	1/1	2/2	3/3	4/4	5/5	2/2	1/1	8/8
#10	LUMINAIRES	2	2	2	2	2	2	2	- 1
VIDEO	DETECTION CABLE	_	1	1	2	2	1	1	4
	-	1	1	2	2	1	1	4	
	_		_	_	1	1	1	2	
1.	-		_			_	-	1	
C	8	20	26	22	26	22	16	40	
	3"	3"	3"	4"	4"	3"	3"	2-3" (E)	

ALL CONDUCTORS CABLES AND CONDUITS ARE NEW UNLESS NOTED OTHERWISE.

AECOM AECOM Technical Services, Inc. 515 S. FLONER ST., 4th FLOOR LOS ANGELES, CA 90071 T 213.330.7200 F 213.330.7201



REVISIONS MARK DATE DESCRIPTION

CITY OF INGLEWOOD, CALIFORNIA PUBLIC WORKS DEPARTMENT

PLANS FOR IMPROVEMENT OF CENTURY BOULEVARD DOTY AVE TO VAN NESS AVE TRAFFIC SIGNAL PLANS - VILLAGE DRIVE


CITY OF INGLEWOOD MAINTAINED PERCENTAGE SHARE 100% CITY OF INGLEWOOD

5/18/2015

TS-406A SHEET NO. 110 OF 215

HORIZONTAL



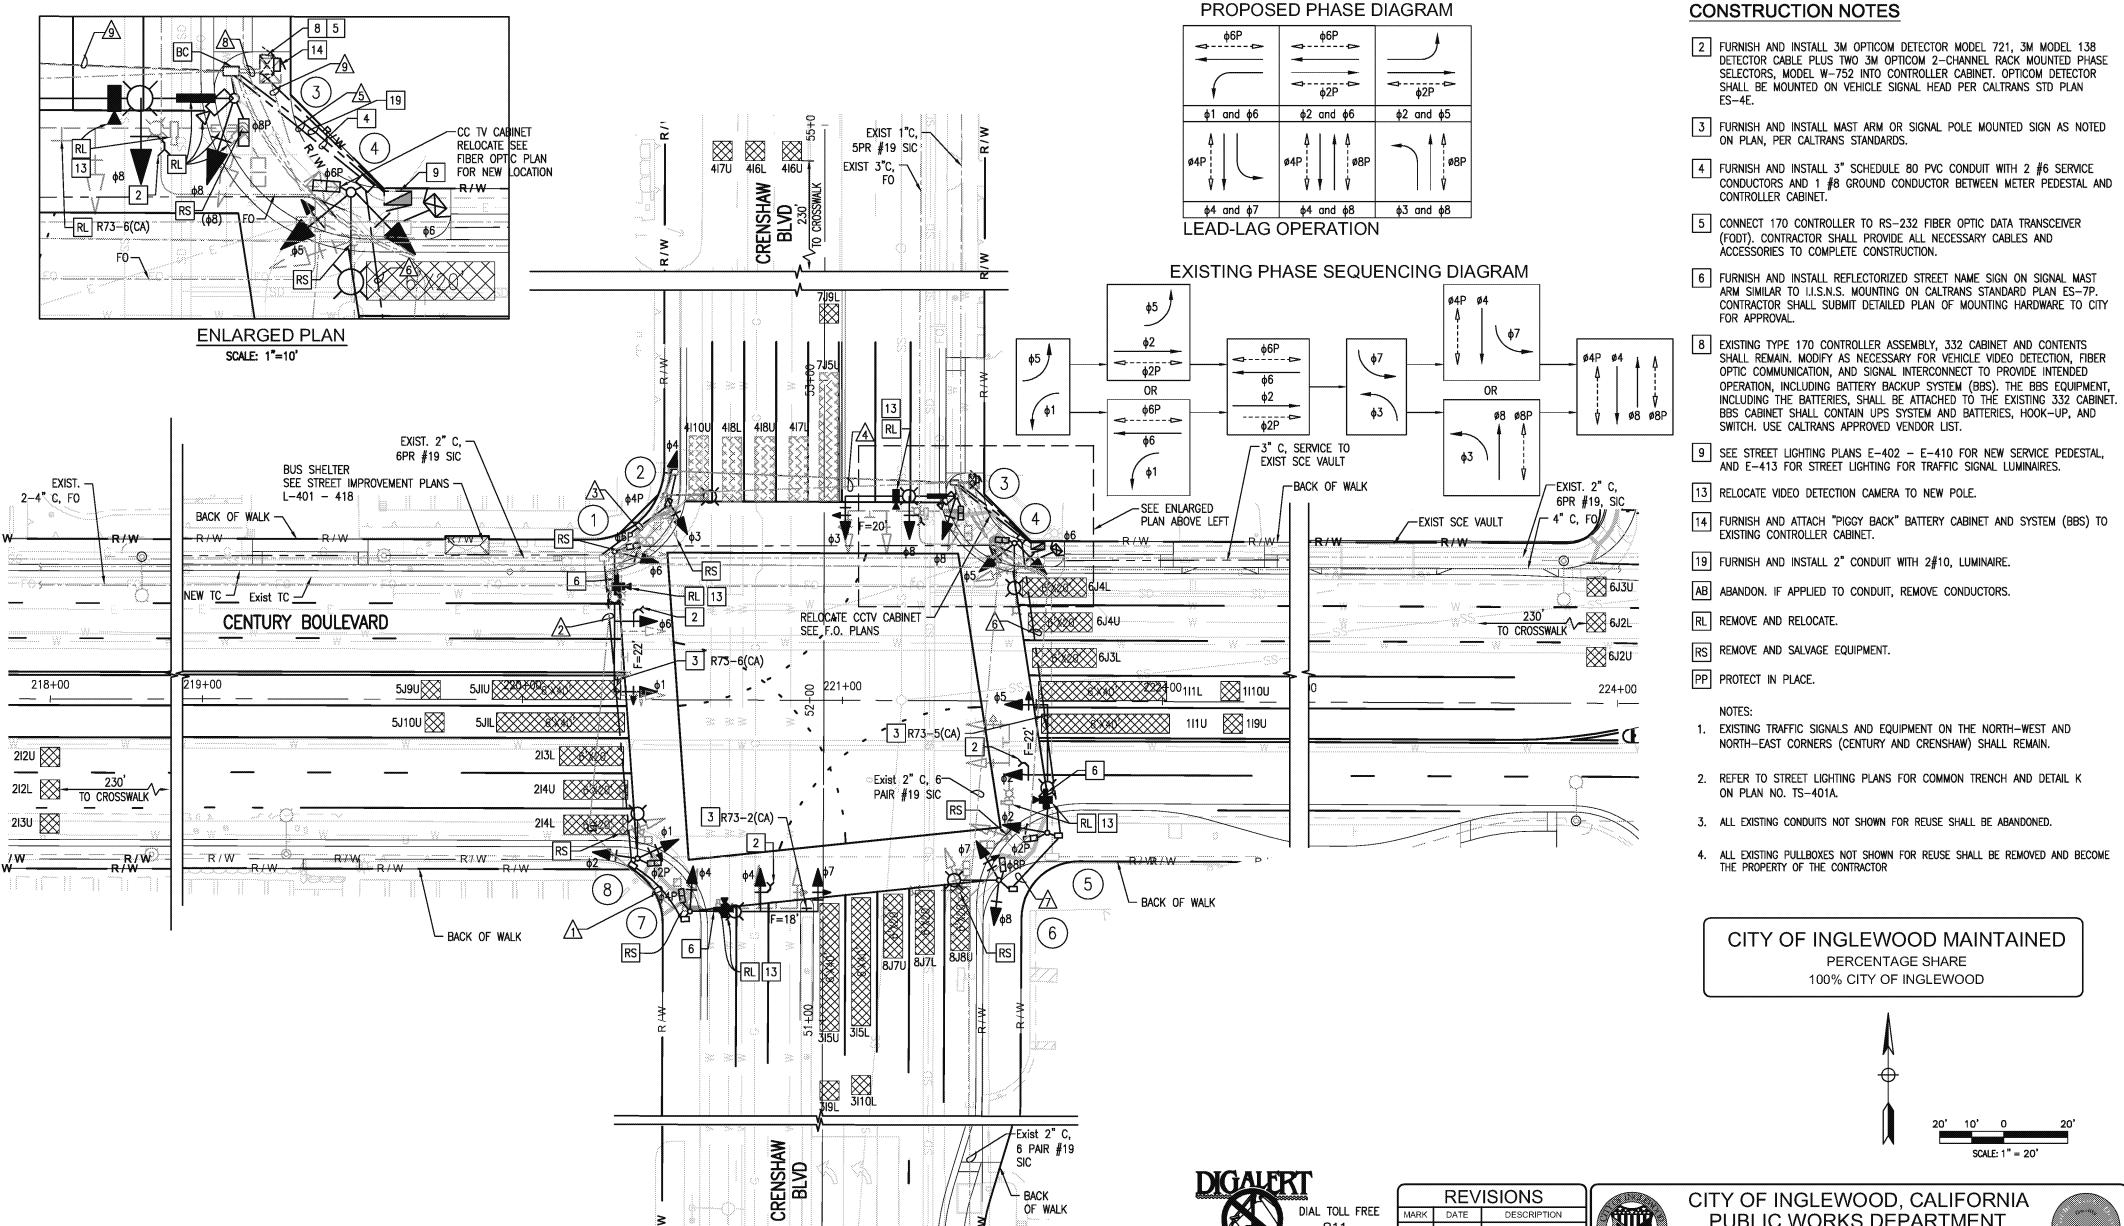

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TS-407 Muse 5/18/2015 SHEET NO. 111 OF 215

CITY OF INGLEWOOD, CALIFORNIA

PUBLIC WORKS DEPARTMENT

PLANS FOR IMPROVEMENT OF **CENTURY BOULEVARD**

DOTY AVE TO VAN NESS AVE

TRAFFIC SIGNAL PLANS - CRENSHAW BLVD

REVISIONS

DESCRIPTION

MARK DATE

DIAL TOLL FREE

811

No. 54987 EXP. 6/30/16

UNDERGROUND SERVICE ALERT OF SOUTHERN CALIFORNIA

AECOM

AECOM Technical Services, Inc. 515 S. FLOWER ST., 4th FLOOR LOS ANGELES, CA 90071 T 213.330.7200 F 213.330.7201

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	POLE AND EQUIPMENT SCHEDULE														
		STANDAR	:D		LED		SIG	NAL MOUNT	r	1	PED PUSH BUTTON (2) SEE DETAIL "C"*			CATION TAIL "B"*	
NO.		T	SIGNAL	LUM.	LUMINAIRE	S.N.S LEGEND	VEH	ICLE	PED				OLL DL		REMARKS
	TYPE	HEIGHT	M. A.	M. A.	201111011112		M. A.	POLE	(1)	QUAD.	PHASE	ARROW	A	В	
1	26-4-100	30'	45'	12'	196W	Crenshaw	2-MAS	SV-1-T	SP-1-T	1	4	-	6.7'	3.4'	_ _
2	15TS	30'	_	12'	196W	-	_	SV-2-T	SP-1-T	3	6		3'	4.5'	<u>-</u>
3	26-4-100	30'	35'	12'	196W	Century	2-MAS	SV-1-T	SP-1-T	3	6		3'	3'	_ _
4	15TS	30'	_	12'	196W	-	-	SV-2-T	SP-1-T	4	8		5'	5'	_
(5)	26-4-100	30'	40'	12'	196W	Crenshaw	2-MAS	SV-1-T	SP-1-T	4	8	-	13'	4.7'	<u>-</u>
6	15TS	30'	_	12'	196W	-	_	SV-2-T	SP-1-T	2	2		8'	3.7'	_
7	26-4-100	30'	40'	12'	196W	Century	2-MAS	SV-1-T	SP-1-T	2	2	-	5'	3'	<u>-</u>
8	15TS	30'	_	12'	196W	_	_	SV-2-T	SP-1-T	1	4		5'	3'	-

ALL EQUIPMENT IS NEW UNLESS NOTED OTHERWISE.

* SEE SHEET TS-401C (1) LED COUNTDOWN PEDESTRIAN SIGNAL FACE. (2) ACCESSIBLE PEDESTRIAN SIGNAL.

CONDUCTOR AND CONDUIT SCHEDULE										
AWG SIZE		CONDUIT LOCATION								
OR CABLE TYPE	POLE & PHASES	\triangle	2	$\sqrt{3}$	4	<u></u>	6	<u> </u>	8	
/	→ Ø1, Ø6, Ø6p, Ø4PPB	-/-	-/-	1/1	1/1	-/-	-/-	-/-	1/1	
12 CABLE	② - ø3, ø4, ø4P, ø6PPB	-/-	-/-	-/-	1/1	-/-	-/-	-/-	1/1	
/	③ - ø3, ø8, ø8P, ø6PPB	-/-	-/-	-/-	-/-	-/-	-/-	-/-	1/1	
11-#14 1-#12	④ − Ø5, Ø6, Ø6P, Ø8PPB	-/-	-/-	-/-	-/-	1/1	-/-	-/-	1/1	
	⑤ – ø2, ø5, ø2P, ø8PPB	-/-	-/-	-/-	-/-	1/1	1/1	-/-	1/1	
(3-#14, PPB)	⑥ − ø7, ø8, ø8P, ø2PPB	-/-	-/-	-/-	-/-	1/1	1/1	1/1	1/1	
/		1/1	1/1	1/1	1/1	-/-	-/-	-/-	1/1	
3 CABLE	8 − Ø1, Ø2, Ø2P, Ø4PPB	-/-	1/1	1/1	1/1	-/-	-/-	-/-	1/1	
	TOTALS: 12 CONDUCTOR / 3 CONDUCTOR	1/1	2/2	3/3	4/4	3/3	2/2	1/1	8/8	
#10	LUMINAIRES	2	2	2	2	2	2	2	-	
VIDEC	DETECTION CABLE	1	1	2	2	2	1	-	4	
	1	1	2	2	2	1	-	4		
	_	_	-	-	_	_	_	2		
1	_	_	_	-	-	_	-	1		
С	13	20	18	22	18	20	8	40		
	3"	3"	4"	4"	4"	3"	3"	2-3" (E)		

ALL CONDUCTORS CABLES AND CONDUITS ARE NEW UNLESS NOTED OTHERWISE. (E) = EXISTING







REVISIONS MARK DATE DESCRIPTION

CITY OF INGLEWOOD, CALIFORNIA PUBLIC WORKS DEPARTMENT

PLANS FOR IMPROVEMENT OF CENTURY BOULEVARD DOTY AVE TO VAN NESS AVE

TRAFFIC SIGNAL PLANS - CRENSHAW BLVD

5/18/2015 SHEET NO. 112 OF 215

PERCENTAGE SHARE 100% CITY OF INGLEWOOD


TS-407A

HORIZONTAL

ST-4696

CITY OF INGLEWOOD MAINTAINED



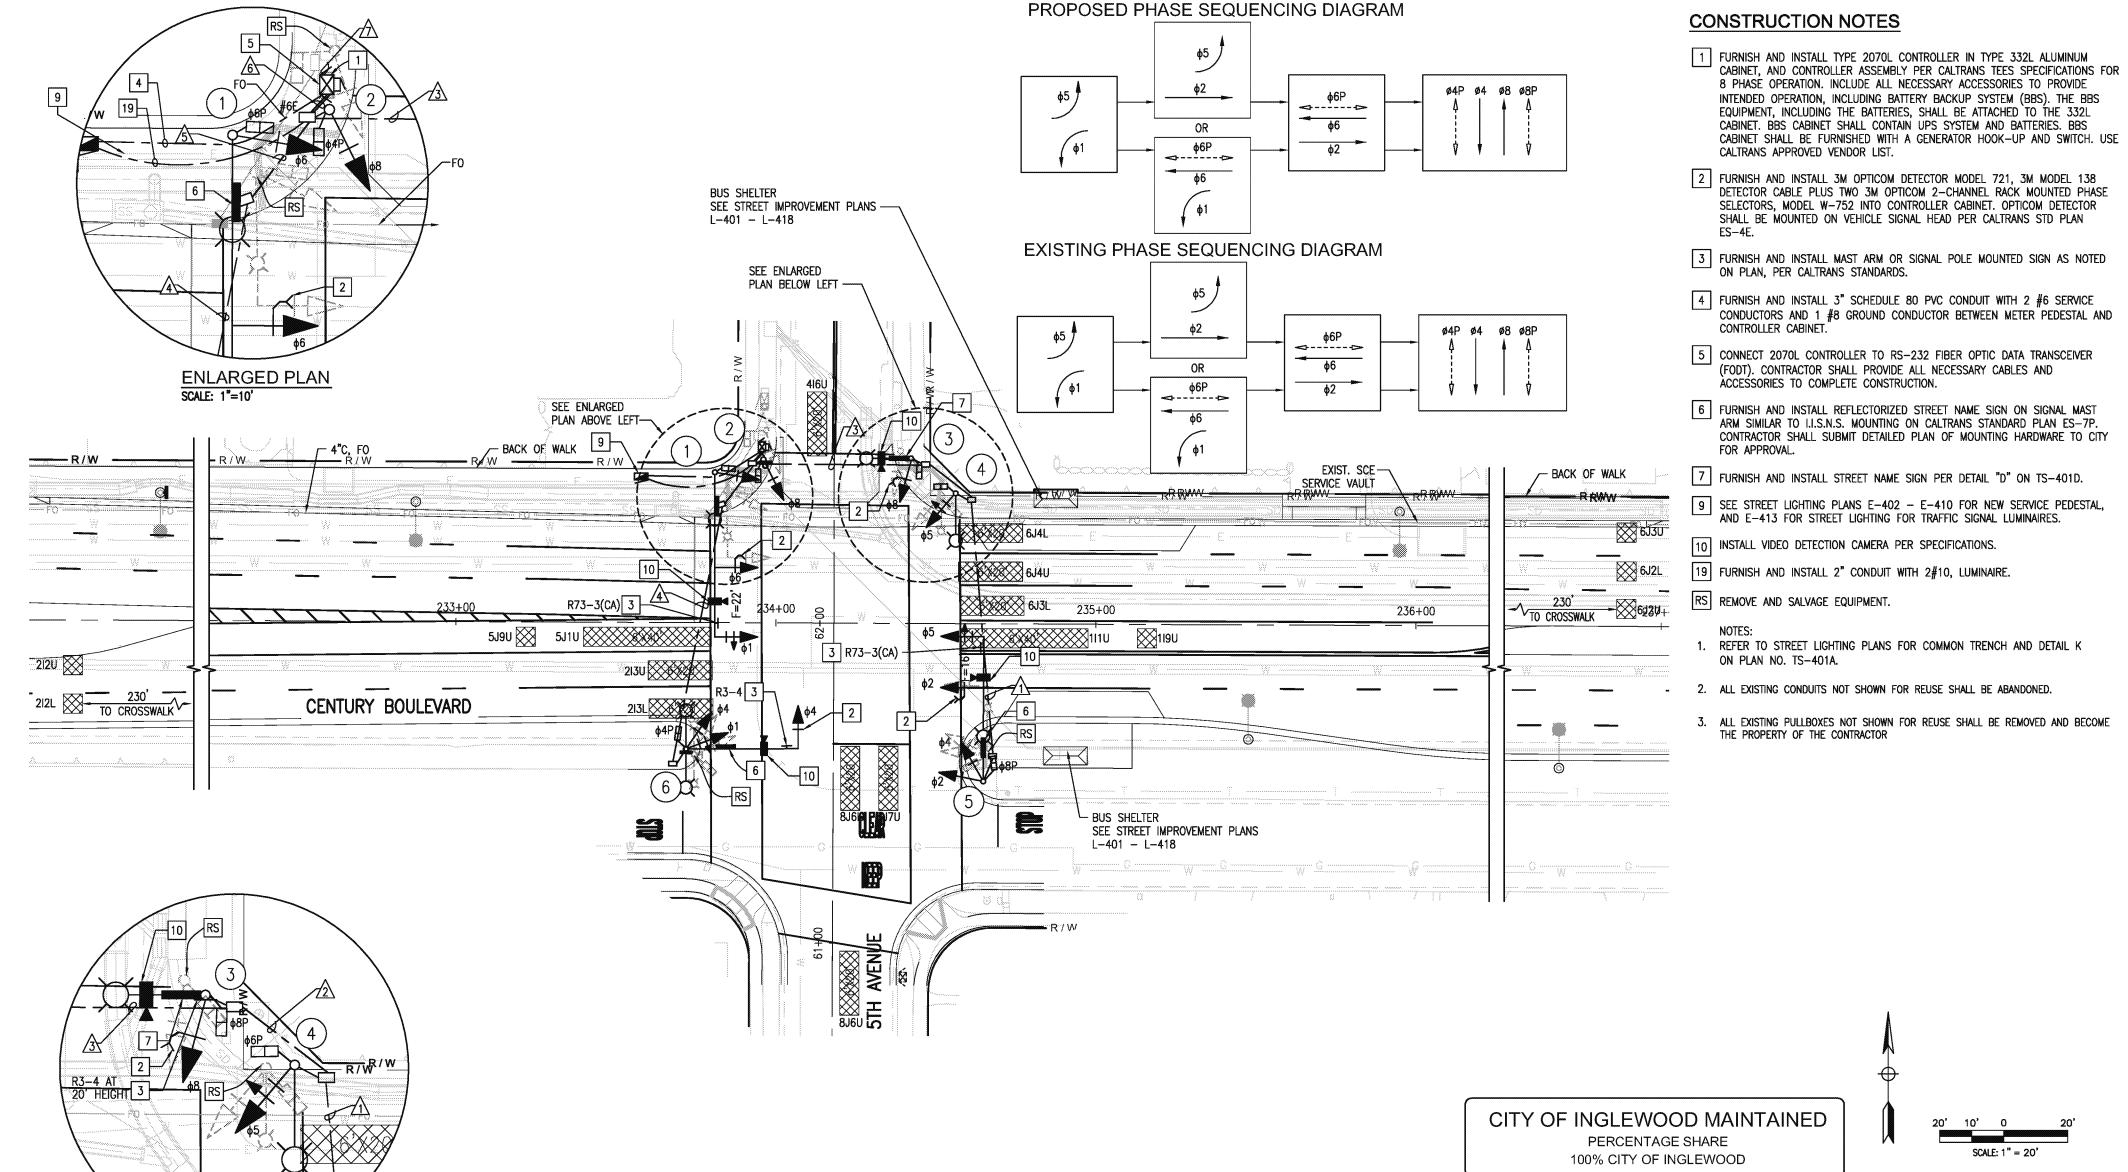

REVISIONS MARK DATE DESCRIPTION

CITY OF INGLEWOOD, CALIFORNIA PUBLIC WORKS DEPARTMENT

> PLANS FOR IMPROVEMENT OF **CENTURY BOULEVARD** DOTY AVE TO VAN NESS AVE

TRAFFIC SIGNAL PLANS - 5th AVENUE


5/18/2015

DIAL TOLL FREE 811 UNDERGROUND SERVICE ALERT OF SOUTHERN CALIFORNIA







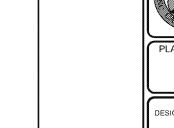





TS-408 SHEET NO. 113 OF 215

ENLARGED PLAN

SCALE: 1"=10'

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						POLE AN	D EQUIF	PMENT	SCHED	ULE					
NO.	5	STANDAR	D		LED	S.N.S LEGEND	SIGNAL WOONTING			PED PUSH BUTTONS (2) SEE DETAIL "C"*			POLE LOCATION SEE DETAIL "B"*		
	TYPE	HEIGHT	SIGNAL M. A.	LUM. M. A.	LUMINAIRE		M. A.	POLE	PED (1)	QUAD.	PHASE	ARROW	Α	В	REMARKS
0	26-4-100	30'	45'	15'	196W	5th Av	2-MAS	SV-1-T	SP-1-T	2	4		4.6'	3'	
2	1A	10'	_	_	-	-	-	TV-1-T	SP-1-T	3	6		7'	3'	
3	15TS	30'	_	12'	196W	Century	-	SV-1-T	SP-1-T	3	6		5'	5'	S.N.S PER DETAIL "D" SHEET TS-401C
4	15TS	30'	_	12'	196W	-	-	SV-1-T	SP-1-T	4	8		5'	7'	_ _
(5)	26-4-100	30'	45'	15'	196W	5th Av	2-MAS	SV-2-T	SP-1-T	4	8		STA. 234+61	1.8'	-
6	24-4-100	30'	35'	2-10'**	2-196W**	Century	MAS	SV-2-T	SP-1-T	2	4		STA. 233+75	1.5'	- -

NOTE: ALL EQUIPMENT IS NEW UNLESS NOTED OTHERWISE.

**= LUMINAIRES TO BE IN CONFORMANCE WITH LUMINAIRE MAST ARM BASE PLATE DETAILS

SHOWN ON CALTRANS STANDARD PLAN ES-6D. THE LUMINAIRE MAST ARMS TO BE A 90° TO SMA.

* SEE SHEET TS-401C

(1) LED COUNTDOWN PEDESTRIAN SIGNAL FACE.

(2) ACCESSIBLE PEDESTRIAN SIGNAL.

1												
CONDUCTOR AND CONDUIT SCHEDULE												
AWG SIZE		CONDUIT LOCATION										
OR CABLE TYPE	POLE & PHASES	Λ	2	$\sqrt{3}$	4	5	6	\overline{A}				
	① - Ø1, Ø6, Ø6P, Ø4PPB	-/-	-/-	-/-	-/-	1/1	1/1	-/-				
CABLE	② - ø8, ø4P, ø6PPB	-/-	-/-	-/-	-/-	-/-	1/1	-/-				
11-#14 1-#12	③ - Ø8, Ø8P, Ø6PPB	-/-	-/-	1/1	-/-	-/-	1/1	-/-				
1-#12	♠ - Ø5, Ø6P, Ø8PPB	-/-	1/1	1/1	-/-	-/-	1/1	-/-				
(3-#14, PPB)	⑤ – ø2, ø4, ø5, ø8P, ø8PPB	2/1	2/1	2/1	-/-	-/-	2/1	-/-				
3	6 – ø1, ø4, ø4P, ø4PPB	-/-	-/-	-/-	1/1	1/1	1/1	-/-				
CABLE	TOTALS: 12 CONDUCTOR / 3 CONDUCTOR	2/1	3/2	4/3	1/1	2/2	7/6	-/-				
#10	LUMINAIRES	2	2	2	2	2	_	-				
VIDEO	VIDEO DETECTION CABLE						4	-				
	1	1	1	1	2	3	-					
1:	_		_			-	1					
С	ONDUIT % FILL	18	24	20	13	25	18	-				
	CONDUIT SIZE	3"	3"	4"	3"	3"	2-4"	3"*				


ALL CONDUCTORS CABLES AND CONDUITS ARE NEW UNLESS NOTED OTHERWISE.


* SEE FIBEROPTIC PLANS FOR CONDUIT SIZE, FO CABLE LOCATION.







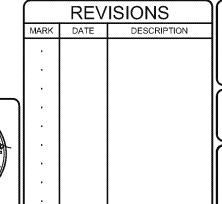

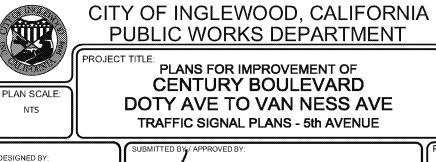

PLANS FOR IMPROVEMENT OF CENTURY BOULEVARD DOTY AVE TO VAN NESS AVE TRAFFIC SIGNAL PLANS - 5th AVENUE


HORIZONTAL

CITY OF INGLEWOOD MAINTAINED PERCENTAGE SHARE 100% CITY OF INGLEWOOD

> TS-408A SHEET NO. 114 OF 215

5/18/2015 DATE



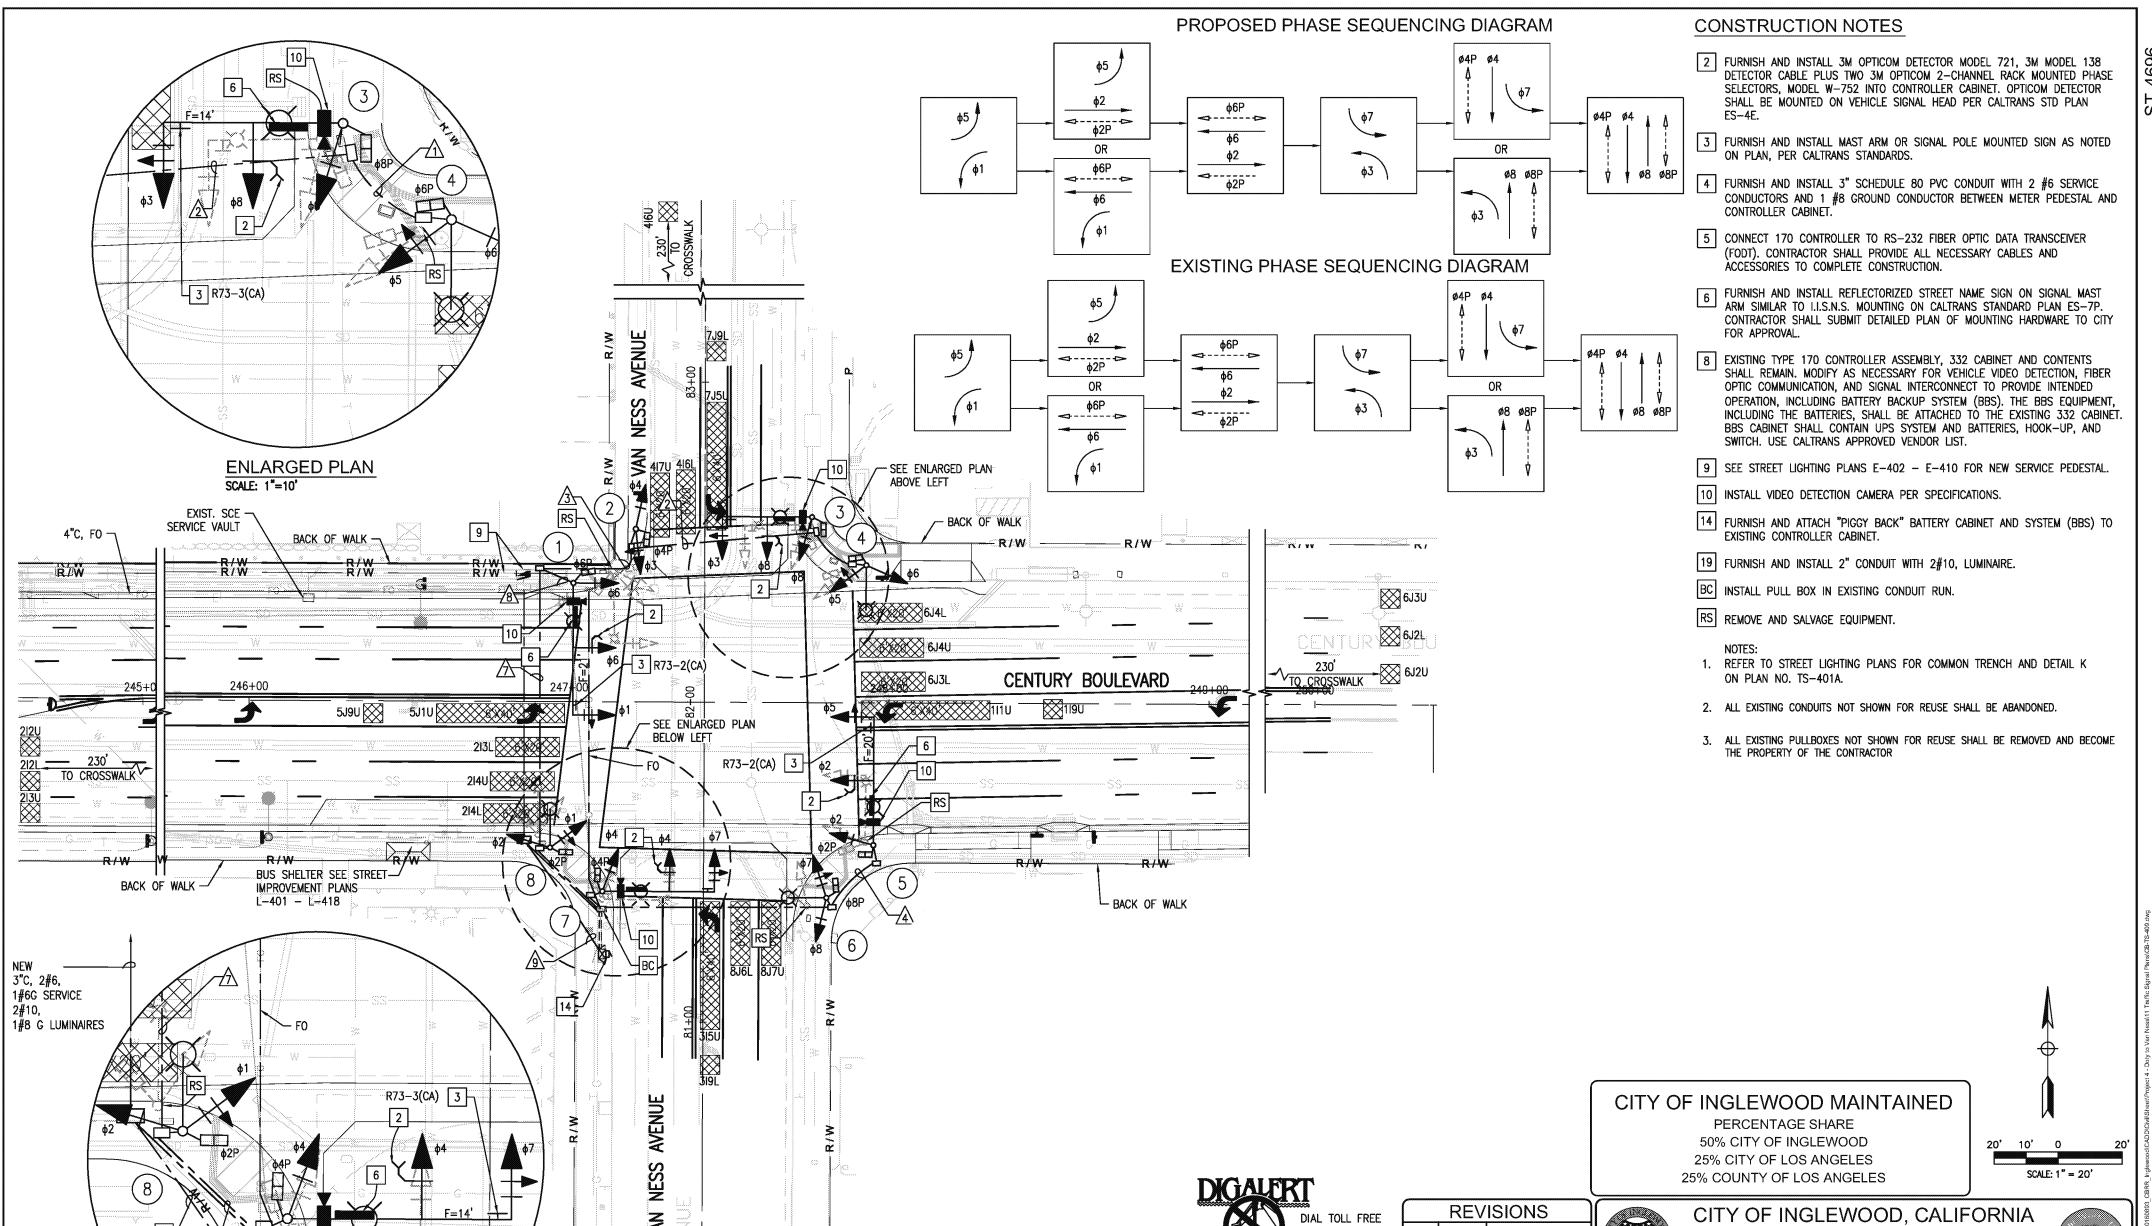

MARK DATE DESCRIPTION

811 AT LEAST TWO DAYS BEFORE YOU DIG

UNDERGROUND SERVICE ALERT OF SOUTHERN CALIFORNIA

AECOM

AECOM Technical Services, Inc. 515 S. FLOWER ST., 4th FLOOR LOS ANGELES, CA 90071 T 213.330.7200 F 213.330.7201

ENLARGED PLAN

SCALE: 1"=10'

TS-409 SHEET NO. 115 OF 215

5/18/2015

PUBLIC WORKS DEPARTMENT

PLANS FOR IMPROVEMENT OF

CENTURY BOULEVARD DOTY AVE TO VAN NESS AVE

TRAFFIC SIGNAL PLANS - VAN NESS AVENUE

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						POLE AN	D EQUI	PMENT	SCHED	ULE						
		STANDAR	D		LED LUMINAIRE		SIGNAL WOONTING		PED PUSHING BUTTONS (2) SEE DETAIL "C"*			POLE LOCATION SEE DETAIL "B"*				
NO.	TYPE	HEIGHT	SIGNAL M. A.	LUM. M. A.		R.S.N.S LEGEND	M. A.	POLE	PED (1)	QUAD.	1	ARROW	A	В	RE	EMARKS
1	26-4-100	30'	40'	12'	196W	Van Ness	2-MAS	SV-1-T	SP-1-T	2	4	-	2'	3'		
2	1A	10'	_	_	_	-	_	TV-2-T	SP-1-T	3	6		5'	3'	_	·
3	19-4-100	30'	30'	12'	196W	Century	2-MAS	SV-1-T	SP-1-T	3	6	-4	2'	5'		
4	15TS	30'	-	12'	196W	-	-	SV-2-T	SP-1-T	4	8		2.5'	5'	_	
(5)	26-4-100	30'	40'	12'	196W	Van Ness	2-MAS	SV-1-T	SP-1-T	4	8		4.5'	3'	_	
6	15TS	30'	-	12'	196W	-	-	SV-2-T	SP-1-T	1	2		10'	4'	_	
7	24-4-100	30'	35'	12'	196W	Century	2-MAS	SV-1-T	SP-1-T	1	2	-4	5'	3'	_	
8	15TS	30'	-	12'	196W	-	_	SV-2-T	SP-1-T	2	4		5'	3'	_	

ALL EQUIPMENT IS NEW UNLESS NOTED OTHERWISE.

* SEE SHEET TS-401C

(1) LED COUNTDOWN PEDESTRIAN SIGNAL FACE.(2) ACCESSIBLE PEDESTRIAN SIGNAL.

CONDUCTOR AND CONDUIT SCHEDULE											
AWG SIZE		CONDUIT LOCATION									
OR CABLE TYPE	POLE & PHASES	Λ	2	$\sqrt{3}$	4	<u></u>	6	<u>/</u>	8		
	① - Ø1, Ø6, Ø6P, Ø4PPB	-/-	-/-	-/-	-/-	-/-	1/1	1/1	1/1		
12 CABLE	② - ø3, ø4, ø4P, ø6PPB	-/-	-/-	1/1	-/-	-/-	1/1	1/1	1/1		
	③ - ø3, ø8, ø8P, ø6PPB	-/-	1/1	1/1	-/-	-/-	1/1	1/1	1/1		
11-#14 1-#12	♠ - ø5, ø6, ø6P, ø8PPB	1/1	1/1	1/1	-/-	-/-	1/1	1/1	1/1		
	⑤ – ø2, ø5, ø2P, ø8PPB	-/-	-/-	-/-	1/1	1/1	-/-	-/-	1/1		
(3-#14, PPB)	6 – ø7, ø8, ø8P, ø2PPB	-/-	-/-	-/-	-/-	1/1	-/-	-/-	1/1		
	⑦ - ø4, ø7, ø4P, ø2PPB	-/-	-/-	-/-	-/-	-/-	-/-	-/-	1/1		
3 CABLE	⑧ − ø1, ø2, ø2P, ø4PPB	-/-	-/-	-/-	-/-	-/-	1/1	-/-	1/1		
	TOTALS: 12 CONDUCTOR / 3 CONDUCTOR	1/1	2/2	3/3	1/1	2/2	5/5	4/4	8/8		
#10	LUMINAIRES	2	2	2	2	2	2	2	-		
VIDEO	-	1	1	1	1	2	2	4			
	_	1	1	1	1	2	2	4			
1.	2 SMFO CABLE	-	_	_			_		1		
С	ONDUIT % FILL	8	20	26	13	20	24	22	38		
	CONDUIT SIZE	3"	3"	3"	3"	3"	4"	4"	2-3" (E)		

ALL CONDUCTORS AND CABLES ARE NEW UNLESS NOTED OTHERWISE.
(E) = EXISTING







REVISIONS MARK DATE DESCRIPTION

CITY OF INGLEWOOD, CALIFORNIA

PUBLIC WORKS DEPARTMENT PLANS FOR IMPROVEMENT OF CENTURY BOULEVARD

DOTY AVE TO VAN NESS AVE TRAFFIC SIGNAL PLANS - VAN NESS AVENUE

HORIZONTAL

CITY OF INGLEWOOD MAINTAINED PERCENTAGE SHARE 50% CITY OF INGLEWOOD 25% CITY OF LOS ANGELES 25% COUNTY OF LOS ANGELES

TS-409A 5/18/2015 SHEET NO. 116 OF 215