

CITY OF INGLEWOOD, CALIFORNIA PUBLIC WORKS DEPARTMENT PLANS FOR IMPROVEMENT OF CENTURY BOULEVARD FELTON AVE TO INGLEWOOD AVE

TRAFFIC SIGNAL KEY PLAN

HORIZONTAL

TS-200 5/18/2015 DATE SHEET NO. 31 OF 67

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GENERAL NOTES

- 1. ALL WORK, MATERIALS AND EQUIPMENT SHALL BE FURNISHED BY THE CONTRACTOR AND SHALL CONFORM TO CALTRANS 2010 STANDARD PLANS, AND STANDARD SPECIFICATIONS, AND 2014 CALIFORNIA MANUAL OF UNIFORM TRAFFIC CONTROL DEVICES (MUTCD).
- 2. THE CONTRACTOR SHALL OBTAIN ALL NECESSARY PERMITS AND NOTIFY ALL AFFECTED UTILITY COMPANIES AND AGENCIES AT LEAST 72 HOURS IN ADVANCE OF CONSTRUCTION.
- 3. POLE, DETECTOR AND EQUIPMENT LOCATIONS ARE APPROXIMATE. THE ENGINEER SHALL APPROVE THE EXACT LOCATIONS OF ALL EQUIPMENT PLACEMENT IN THE FIELD PRIOR TO INSTALLATION. CONTRACTOR SHALL POTHOLE CONFLICTING UTILITIES AS DIRECTED BY THE ENGINEER.
- 4. ALL VEHICLE INDICATIONS SHALL BE 12" DIAMETER WITH METAL BACK PLATE AND METAL VISOR. SIGNAL SECTION HOUSING SHALL BE METAL. VEHICLE INDICATIONS SHALL BE (RED, YELLOW AND GREEN) AND SHALL UTILIZE LIGHT EMITTING DIODE (LED) SIGNAL MODULES. PEDESTRIAN INDICATIONS SHALL UTILIZE INTERNATIONAL SYMBOL AND UTILIZE LED COUNT DOWN MODULES. PEDESTRIAN BUSH BUTTONS SHALL BE TYPE "B" ADA TYPE WITH INTERNATIONAL SYMBOL PLATE.
- 5. ALL PULL BOXES SHALL BE NO. 5, UNLESS OTHERWISE NOTED, AND HAVE A MAXIMUM SPACING OF 200' BETWEEN PULL BOXES. PULL BOXES AND COVERS SHALL BE CONCRETE. COVERS SHALL HAVE THE MARKING "TRAFFIC SIGNAL." PULL BOX ADJACENT TO THE CONTROLLER CABINET SHALL BE TYPE 6E. PULL BOXES WITH 4 OR MORE CONDUITS SHALL BE TYPE 6E.
- 6. FLASHING SIGNAL OPERATION SHALL BE RED ON ALL PHASES.
- 7. ALL TRAFFIC SIGNAL INTERCONNECT CONDUIT SHALL BE TYPE 3, SCHEDULE 80, UNLESS OTHERWISE NOTED, WITH MIN 30" COVER.
- 8. TRAFFIC SIGNAL INTERCONNECT SHALL BE INSTALLED WITH 6 PAIR 19 SIGNAL INTERCONNECT CABLE, IN A COMMON TRENCH. REFER TO ELECTRICAL PLANS.
- 9. ALL AND VIDEO DETECTOR LOCATIONS AND INSTALLATIONS SHALL BE VERIFIED IN THE FIELD BY THE ENGINEER OR HIS DESIGNATED REPRESENTATIVE BEFORE SAW CUTTING. NECESSARY STRIPING SHALL BE LOCATED PRIOR TO POSITIONING THE DETECTORS.
- 10. INSTALL #8 GROUND CONDUCTOR IN ALL NEW INSTALLED CONDUITS CONTAINING POWER CONDUCTORS AND A #10 GROUND CONDUCTOR IF CONDUIT CONTAINS NO POWER CONDUCTORS.
- 11. TRAFFIC SIGNAL SAFETY LIGHTING LUMINARIES SHALL BE 196 WATT LED WITH TYPE III MEDIUM CUTOFF DISTRIBUTION. REFER TO PROJECT SERVICE NOTE, E-204, E-205.
- 12. CONDUCTOR SCHEDULE IS FURNISHED AS AN INSTALLATION GUIDELINE ONLY. IT SHALL BE THE CONTRACTOR'S RESPONSIBILITY TO PROVIDE THE CORRECT CABLES AND CONDUCTORS REQUIRED FOR THE
- 13. SERVICE EQUIPMENT ENCLOSURE SHALL BE 10' TO 15' FROM THE CONTROLLER, AND SEPARATED FROM ALL UTILITY POLES BY A MINIMUM OF 15 FEET, UNLESS OTHERWISE DIRECTED BY THE ENGINEER. REFER TO DETAIL "H" ON PLAN NO. TS-201A
- 14. ALL NEW INSTALLED 1-A POLE FOUNDATIONS SHALL HAVE ANCHOR BOLTS WITH SLEEVE NUTS PER CALTRANS STD. PLAN ES-7B.
- 15. UNDERGROUND SIGNAL CONDUCTORS SHALL NOT BE SPLICED.
- 16. THE CONTRACTOR SHALL BE RESPONSIBLE FOR PROVIDING A DETAILED TRAFFIC CONTROL PLAN FOR ANY STREET AND DRIVEWAY CLOSURES ASSOCIATED WITH THE TRAFFIC SIGNAL CONSTRUCTION AND SHALL PROVIDE ALL NECESSARY TRAFFIC CONTROL DEVICES DURING THE SIGNAL INSTALLATION, IN ACCORDANCE WITH THE 2014 CALIFORNIA MANUAL OF TRAFFIC CONTROL DEVICES (MUTCD).
- 17. FOR STRIPING DETAILS SEE STRIPING AND SIGNING PLANS (PLAN NUMBERS SPD-201 THROUGH SPD-203).
- 18. ALL SIGN PANELS SHALL CONFORM TO THE CALTRANS SIGN AND SPECIFICATION SHEETS AND SHALL BE MOUNTED ON POST AT 7' HEIGHT FROM GROUND.
- 19. THE EXACT LOCATION OF ALL SIGNS AND PAVEMENT MARKINGS SHALL BE DETERMINED BY THE ENGINEER IN THE
- 20. ALL TRAFFIC SIGNS SHALL BE INSTALLED PRIOR TO TRAFFIC SIGNAL TURN ON.
- 21. ALL PAVEMENT DELINEATION REQUIREMENTS SHALL BE COMPLETED AT LEAST ONE DAY PRIOR TO TRAFFIC SIGNAL
- 22. CONDUIT BETWEEN ADJOINING PULL BOXES SHALL BE 2.5" UNLESS SHOWN OTHERWISE.
- 23. VIDEO VEHICLE DETECTORS SHALL BE CENTERED WITHIN THE LANE AND SHALL BE 6 FEET IN WIDTH. DETECTOR SEALANT SHALL BE HOT MELT RUBBERIZED ASPHALT, PER SECTION 86-5.01A(3)(c) OF THE STANDARD SPECIFICATIONS.
- 24. PULL BOXES SHALL NOT BE LOCATED IN OR WITHIN 12" OF ANY CURB ACCESS RAMP OR DRIVEWAY.
- 25. THE CONTRACTOR SHALL VERIFY WITH THE ENGINEER THE PRECISE FIELD LOCATIONS OF ALL TRAFFIC SIGNAL EQUIPMENT PRIOR TO THE INSTALLATION.
- 26. ALL LANDSCAPING WHICH IS DAMAGED BY CONSTRUCTION ACTIVITIES SHALL BE REPAIRED OR REPLACED TO THE SATISFACTION OF THE CITY.
- 27. NEW MAST ARM MOUNTED REGULATORY SIGNS SHALL BE FABRICATED WITH ASTM TYPE II REFLECTIVE SHEETING OR APPROVED EQUAL.
- 28. STREET NAME SIGNS (SNS) SHALL BE REFLECTORIZED PER SPECIFICATIONS. STREET NAME LEGENDS SHALL BE UPPER/LOWER CASE AND SHALL INCLUDE STREET ADDRESSES AND ROAD NAME SUFFIXES. SUBMIT FULL SIZE COLOR SAMPLE TO THE CITY TRAFFIC ENGINEER FOR APPROVAL PRIOR TO SIGN FABRICATION.
- 29. CONTRACTOR SHALL COORDINATE WITH THE CITY OF INGLEWOOD TRAFFIC SIGNAL MAINTENANCE DEPARTMENT FIVE (5) WORKING DAYS PRIOR TO WORK AFFECTING A TRAFFIC SIGNAL.
- 30. PEDESTRIAN PUSH BUTTONS SHALL BE ADA COMPLIANT AND VIBRO TACTILE. PUSH BUTTONS SHALL BE CONSTRUCTED OF HIGH DENSITY THERMOPLASTIC AND UTILIZE PIEZO SWITCH TECHNOLOGY. PUSH BUTTON COLOR

GENERAL NOTES CONTINUED

SHALL BE YELLOW. OUTER BODY COLOR SHALL BE BLACK. POLARA *MPBP-BY OR CAMPBELL CO. DCC 700P OR EQUAL. SCREWS USED TO SECURE THE SIGN PLATE TO THE HOUSING SHALL BE STAINLESS STEEL 8-32" X 3/8" WITH TAMPER PROOF TORX HEAD. SIZE T-15, OR A CITY APPROVED EQUAL. SUBMIT SAMPLE TO THE CITY TRAFFIC ENGINEER FOR APPROVAL PRIOR TO ORDERING PUSH BUTTON SYSTEMS.

- 31. THE CONTRACTOR SHALL OBTAIN ALL NECESSARY PERMITS AND SHALL NOTIFY ALL AFFECTED AGENCIES AND COMPANIES. INCLUDING THE CITY OF INGLEWOOD, TRAFFIC SIGNAL MAINTENANCE DIVISION, 48 HOURS PRIOR TO START OF CONSTRUCTION.
- 32. EXISTING TRAFFIC SIGNAL HEADS AND POLES SHALL BE REMOVED, INCLUDING ENTIRE POLE FOUNDATIONS (BACKFILLED WITH NATIVE MATERIAL TO 95% RELATIVE COMPACTION) UNLESS NOTED OTHERWISE.
- 33. EXISTING TRAFFIC SIGNAL CONTROLLER CABINETS THAT ARE TO REMAIN IN PLACE AND REUSED, SHALL BE PROTECTED IN PLACE.
- 34. ALL EXISTING CONDUITS NOT SHOWN FOR REUSE SHALL BE ABANDONED.
- 35. ALL EXISTING PULLBOXES NOT SHOWN FOR REUSE SHALL BE REMOVED AND BECOME THE PROPERTY OF THE

ABBREVIATIONS

ACCESSIBLE PEDESTRIAN SIGNAL BATTERY BACKUP SYSTEM (NEW PIGGY BACK)

EMERGENCY VEHICLE PREEMPTION DETECTOR NEW SERVICE, DUAL METER PEDESTAL

STREET LIGHTING

TRAFFIC SIGNAL PHOTO ELECTRIC UNIT

EDGE LIT LED TYPE 'A' STREET NAME SIGN

STANDARD NOTES

- AB ABANDON. IF APPLIED TO CONDUIT, REMOVE CONDUCTORS.
- BC INSTALL PULL BOX IN EXISTING CONDUIT RUN.
- CB INSTALL CONDUIT INTO EXISTING PULL BOX.
- CC CONNECT NEW AND EXISTING CONDUIT. REMOVE EXISTING CONDUCTORS AND INSTALL CONDUCTORS AS INDICATED.
- PP PROTECT IN PLACE
- RC EQUIPMENT OR MATERIAL TO BE REMOVED AND BECOME THE PROPERTY OF THE CONTRACTOR.
- RL RELOCATE EQUIPMENT.
- RS REMOVE AND SALVAGE EQUIPMENT

LEGEND

DUAL METER SERVICE PEDESTAL	W	EXISTING UTILITY
EXISTING CCTV CAMERA	W	PROPOSED UTILITY
PROPOSED CCTV CAMERA	F0	PROPOSED FIBER OPTIC
PROPOSED 3M OPTICOM DETECTOR	F0	EXISTING FIBER OPTIC

PROPOSED VIDEO VEHICLE DETECTION AREA

EXISTING VIDEO VEHICLE DETECTION AREA

CITY OF INGLEWOOD MAINTAINED

PERCENTAGE SHARE 100% CITY OF INGLEWOOD






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UNDERGROUND SERVICE ALERT OF SOUTHERN CALIFORNIA







DESIGNED BY

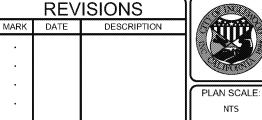CHECKED BY

CITY OF INGLEWOOD, CALIFORNIA PUBLIC WORKS DEPARTMENT PROJECT TITLE

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PLANS FOR IMPROVEMENT OF CENTURY BOULEVARD FELTON AVE TO INGLEWOOD AVE TRAFFIC SIGNAL PLANS - GENERAL NOTES & LEGEND

HORIZONTAL

5/18/2015

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1. BBS CABINET SHALL BE ATTACHED TO THE 332 CONTROLLER CABINET WHERE INDICATED ON THE TRAFFIC SIGNAL PLANS. REFER TO DETAIL "F" HEREON.

BBS FRONT EXTERIOR VIEW PIGGY BACK


2. THE BBS CABINET SHALL CONTAIN THE UPS AND THE BATTERIES.


BBS SIDE VIEW PIGGY BACK

1'-2"


BATTERY BACKUP SYSTEM CABINET (BBS)

DETAIL "G" NOT TO SCALE

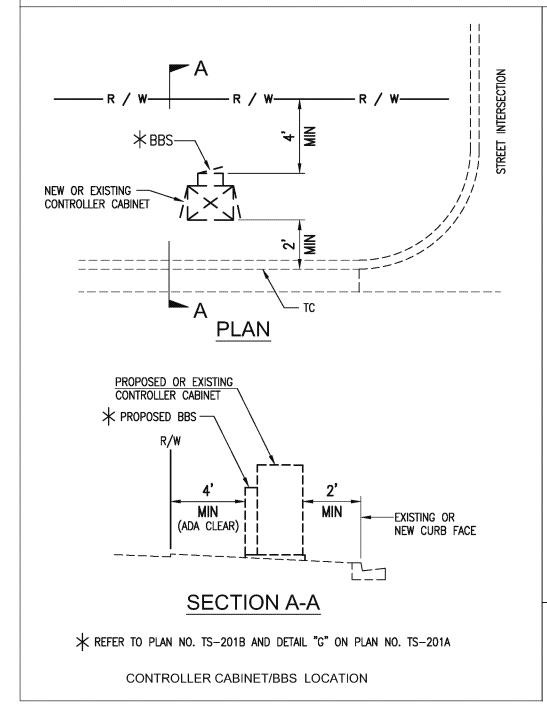


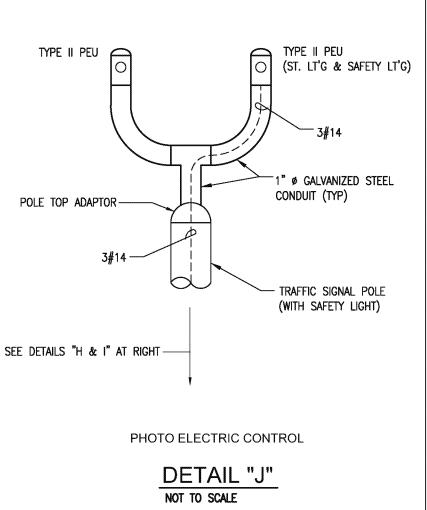

BBS FRONT INTERIOR / EXTERIOR VIEW PIGGY BACK

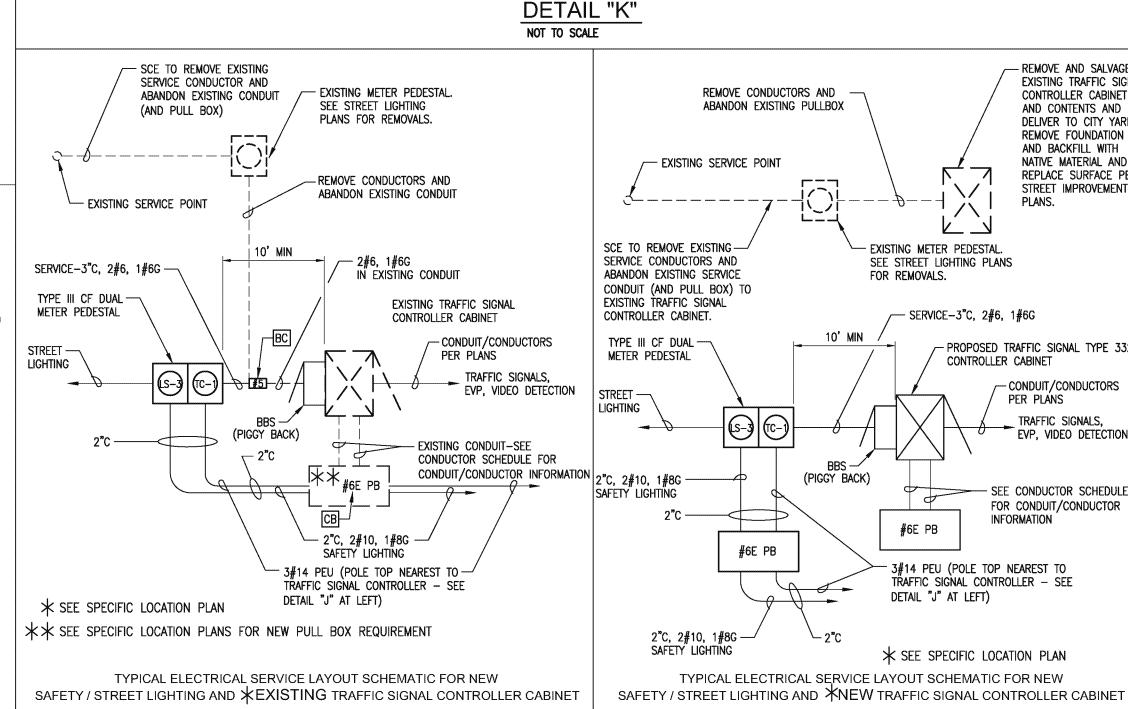

DETAIL "I" NOT TO SCALE

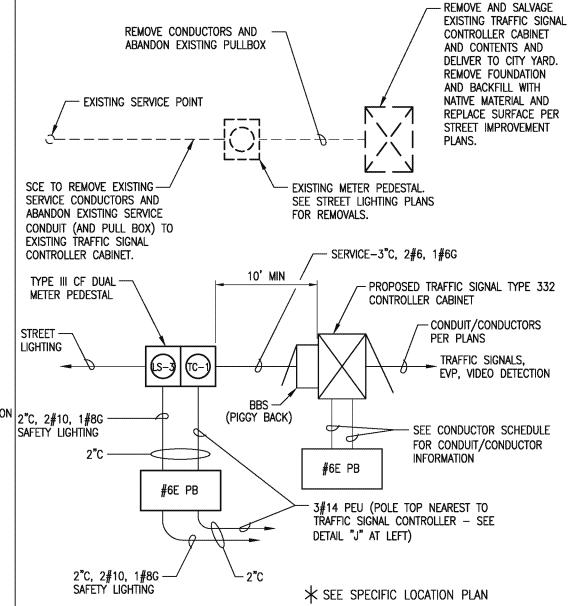

- COMMON TRENCH FOR:

FIBER OPTIC CONDUIT (FO)

STREET LIGHTING CONDUIT (SL)

TRAFFIC SIGNAL INTERCONNECT CONDUIT (SIC)

SEE FO PLANS

REVISIONS MARK DATE DESCRIPTION

WITH TRAFFIC SIGNAL INTERCONNECT (SIC), STREET LIGHTING (SL) & FIBER OPTIC (FO) PULLBOX ARRANGEMENT

CITY OF INGLEWOOD, CALIFORNIA PUBLIC WORKS DEPARTMENT

DETAIL "H"

TYPICAL ELECTRICAL SERVICE LAYOUT SCHEMATIC FOR NEW


NOT TO SCALE

PLANS FOR IMPROVEMENT OF **CENTURY BOULEVARD** FELTON AVE TO INGLEWOOD AVE FRAFFIC SIGNAL PLANS - GENERAL NOTES & DETAILS

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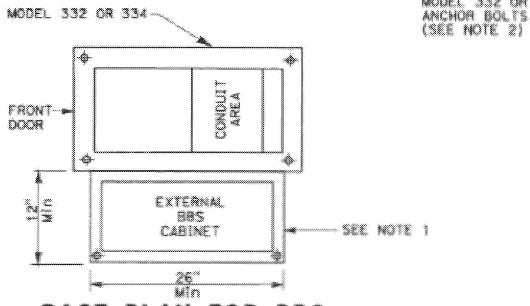
UNDERGROUND SERVICE ALERT OF SOUTHERN CALIFORNIA

TS-201A SHEET NO. 33 OF 67

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SIDE VIEW

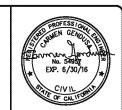EXTERNAL BBS CABINET MOUNTED TO THE MODEL 332 OR 334 CABINET




BASE PLAN FOR BBS MOUNTED TO THE MODEL 332 OR 334 CABINET

(FOR DIMENSIONS AND DETAILS NOT SHOWN, SEE SHEET AR-Y TO A6-4, CABINET HOUSING DETAILS OF THE TRANSPORTATION ELECTRICAL EQUIPMENT SPECIFICATION (TEES))

NOTE: (THIS SHEET ONLY)

4. ALL DIMENSIONS ARE NOMINAL.

- MONIL 330 ON 334 CABINET 1. THE EXTERNAL BBS CABINET SHALL BE MOUNTED TO THE MODEL 332 ON 334 CABINET WITH FOUR 18-8 STAINLESS STEEL HEX HEAD, FULLY-THREADED, 76-16 X 1 BOLTS; TWO WASHERS PER BOLT, DESIGNED FOR 76 BOLTS AND ARE 18-8 STAINLESS STEEL, 1 OUTSIDE DIAMETER, ROUND, AND FLAT; AND ONE K-LOCK HUT TOX NOLT THAT IS 18-8 STAINLESS STEEL AND A HEX-MUT. THE ENGINEER WILL HAVE TO APPROVE THE BOLT WOUNTING LOCATION PRIOR TO INSTALLATION.
 - 2. THE ANCHOR BOLTS SHALL BE 7." DIG X 15" WITH A 2"-90" BEND. THE CABINET WANDFACTURER'S SPECIFICATION SHALL DETERMINE THE LOCATION OF THE ANCHOR BOLTS IN THE FOUNDATION. THE ENGINEER WILL HAVE TO APPROVE THE ANCHOR BOLTS AND ITS LOCATION IN THE FOUNDATION PRIOR TO CONSTRUCTION.
 - 3. THE CONTRACTOR SHALL VERIFY THE DIMENSIONS OF THE BBS CABINET PRIOR TO CONSTRUCTING THE FOUNDATION OF THE MODIFIED PORTION OF THE STO MODEL 332 AND 334 CABINET FOUNDATION. THE ENGINEER WILL HAVE TO APPROVE ANY NECESSARY DEVIATIONS PAIDA TO CONSTRUCTION.

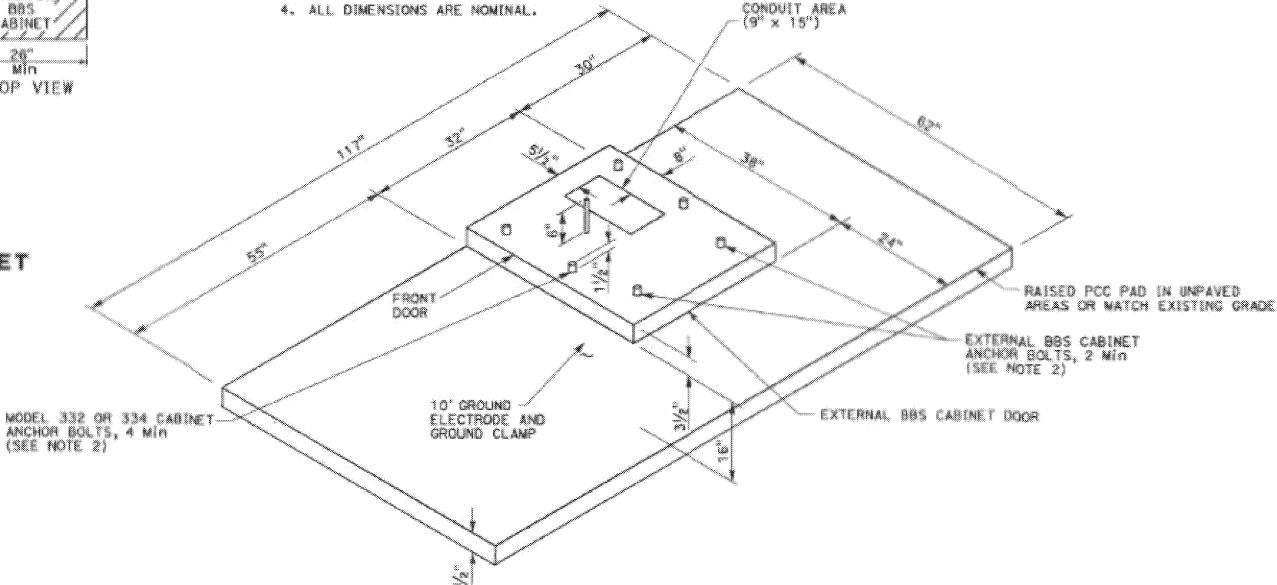

MODIFIED MODEL 332 AND 334 CABINET FOUNDATION DETAIL FOR BATTERY BACKUP SYSTEM (BBS)

(FOR DIMENSIONS AND DETAILS NOT SHOWN AND ADDITIONAL MOTES, SEE SHEET ES-3C OF THE STANDARD PLANS FOR MODEL 332 AND 334 CABINETS)

ELECTRICAL SYSTEMS

(BBS FOUNDATION DETAILS)







REVISIONS MARK DATE DESCRIPTION PLAN SCALE

CITY OF INGLEWOOD, CALIFORNIA PUBLIC WORKS DEPARTMENT

PROJECT TITLE: PLANS FOR IMPROVEMENT OF CENTURY BOULEVARD FELTON AVE TO INGLEWOOD AVE **BBS FOUNDATION DETAILS**

HORIZONTAL

Muse 5/18/2015

CITY OF INGLEWOOD MAINTAINED

PERCENTAGE SHARE

100% CITY OF INGLEWOOD

TS-201B SHEET NO. 34 OF 67

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- DETECTOR (OPTICOM MODEL 711)


DETAIL "E" NOT TO SCALE

SPEED AND VEHICLE DETECTOR DISTANCE FROM LIMIT LINE FOR ADVANCE DETECTION

APPROACH SPEED. MPH	DISTANCE OF ADVANCE LOOP FROM LIMIT LINE, FT*
25	105
30	140
35	185
40	230
45	285


* PER CHAPTER 4D, CALIFORNIA 2014 MUTCD TABLE 4D-101(CA)

> DETAIL"A" NOT TO SCALE

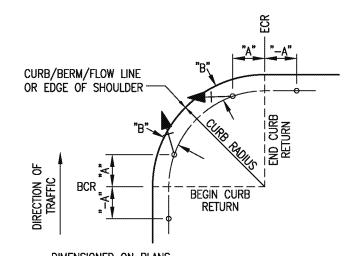


- DIMENSIONED ON PLANS. * TYPICAL SIGNAL STANDARD PLACEMENT
- * FOR "A" AND "B" DIMENSIONS, SEE POLE SCHEDULE OR AS DIRECTED BY THE ENGINEER.


DETAIL"B" NOT TO SCALE

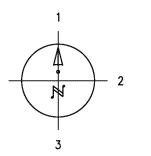

PUSH BUTTON LOCATION

DETAIL"C" NOT TO SCALE

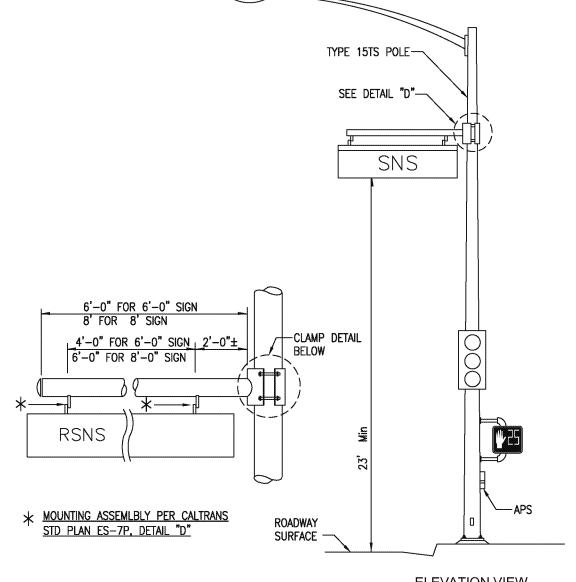

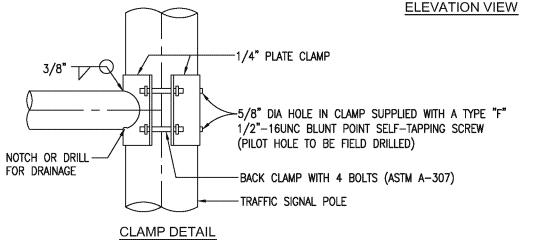

TYPICAL STREET NAME SIGN MAST ARM & MOUNTING FOR TYPE 15 TS

> DETAIL "D" NOT TO SCALE

WARNING:


UTILITY LINES SHOWN ARE BASED UPON A SEARCH OF AVAILABLE RECORDS. THERE IS NO ASSURANCE THAT THE LOCATION OF SUBSTRUCTURES SHOWN ARE ACCURATE. PRIOR TO ANY EXCAVATION WORK, THE CONTRACTOR SHALL NOTIFY UNDERGROUND SERVICE ALERT OF SHALL NOTIFY UNDERGROUND SERVICE ALERT OF SOUTHERN CALIFORNIA (DIGALERT) TO MARK THE LOCATION OF ALL SUBSTRUCTURES, WHETHER SHOWN OR NOT ON THESE DRAWINGS, AT LEAST 48 HOURS PRIOR TO THE COMMENCEMENT OF FIELD MARKING. THE CONTRACTOR SHALL USE PRECAUTION WHEN EXCAVATING. SUBSTRUCTURES ENCOUNTERED SHALL BE EXPOSED AND THE ENGINEER NOTIFIED OF THEIR EXISTENCE. THE CONTRACTOR SHALL BE RESPONSIBLE FOR THE PROTECTION OF ALL SUBSTRUCTURES, WHETHER SHOWN OR NOT, ON THESE DRAWINGS. THE CONTRACTOR SHALL REPAIR, AT OWN EXPENSE, ANY SUBSTRUCTURES DAMAGE CAUSED BY HIS/HER OPERATIONS.


CITY OF INGLEWOOD MAINTAINED


PERCENTAGE SHARE 100% CITY OF INGLEWOOD

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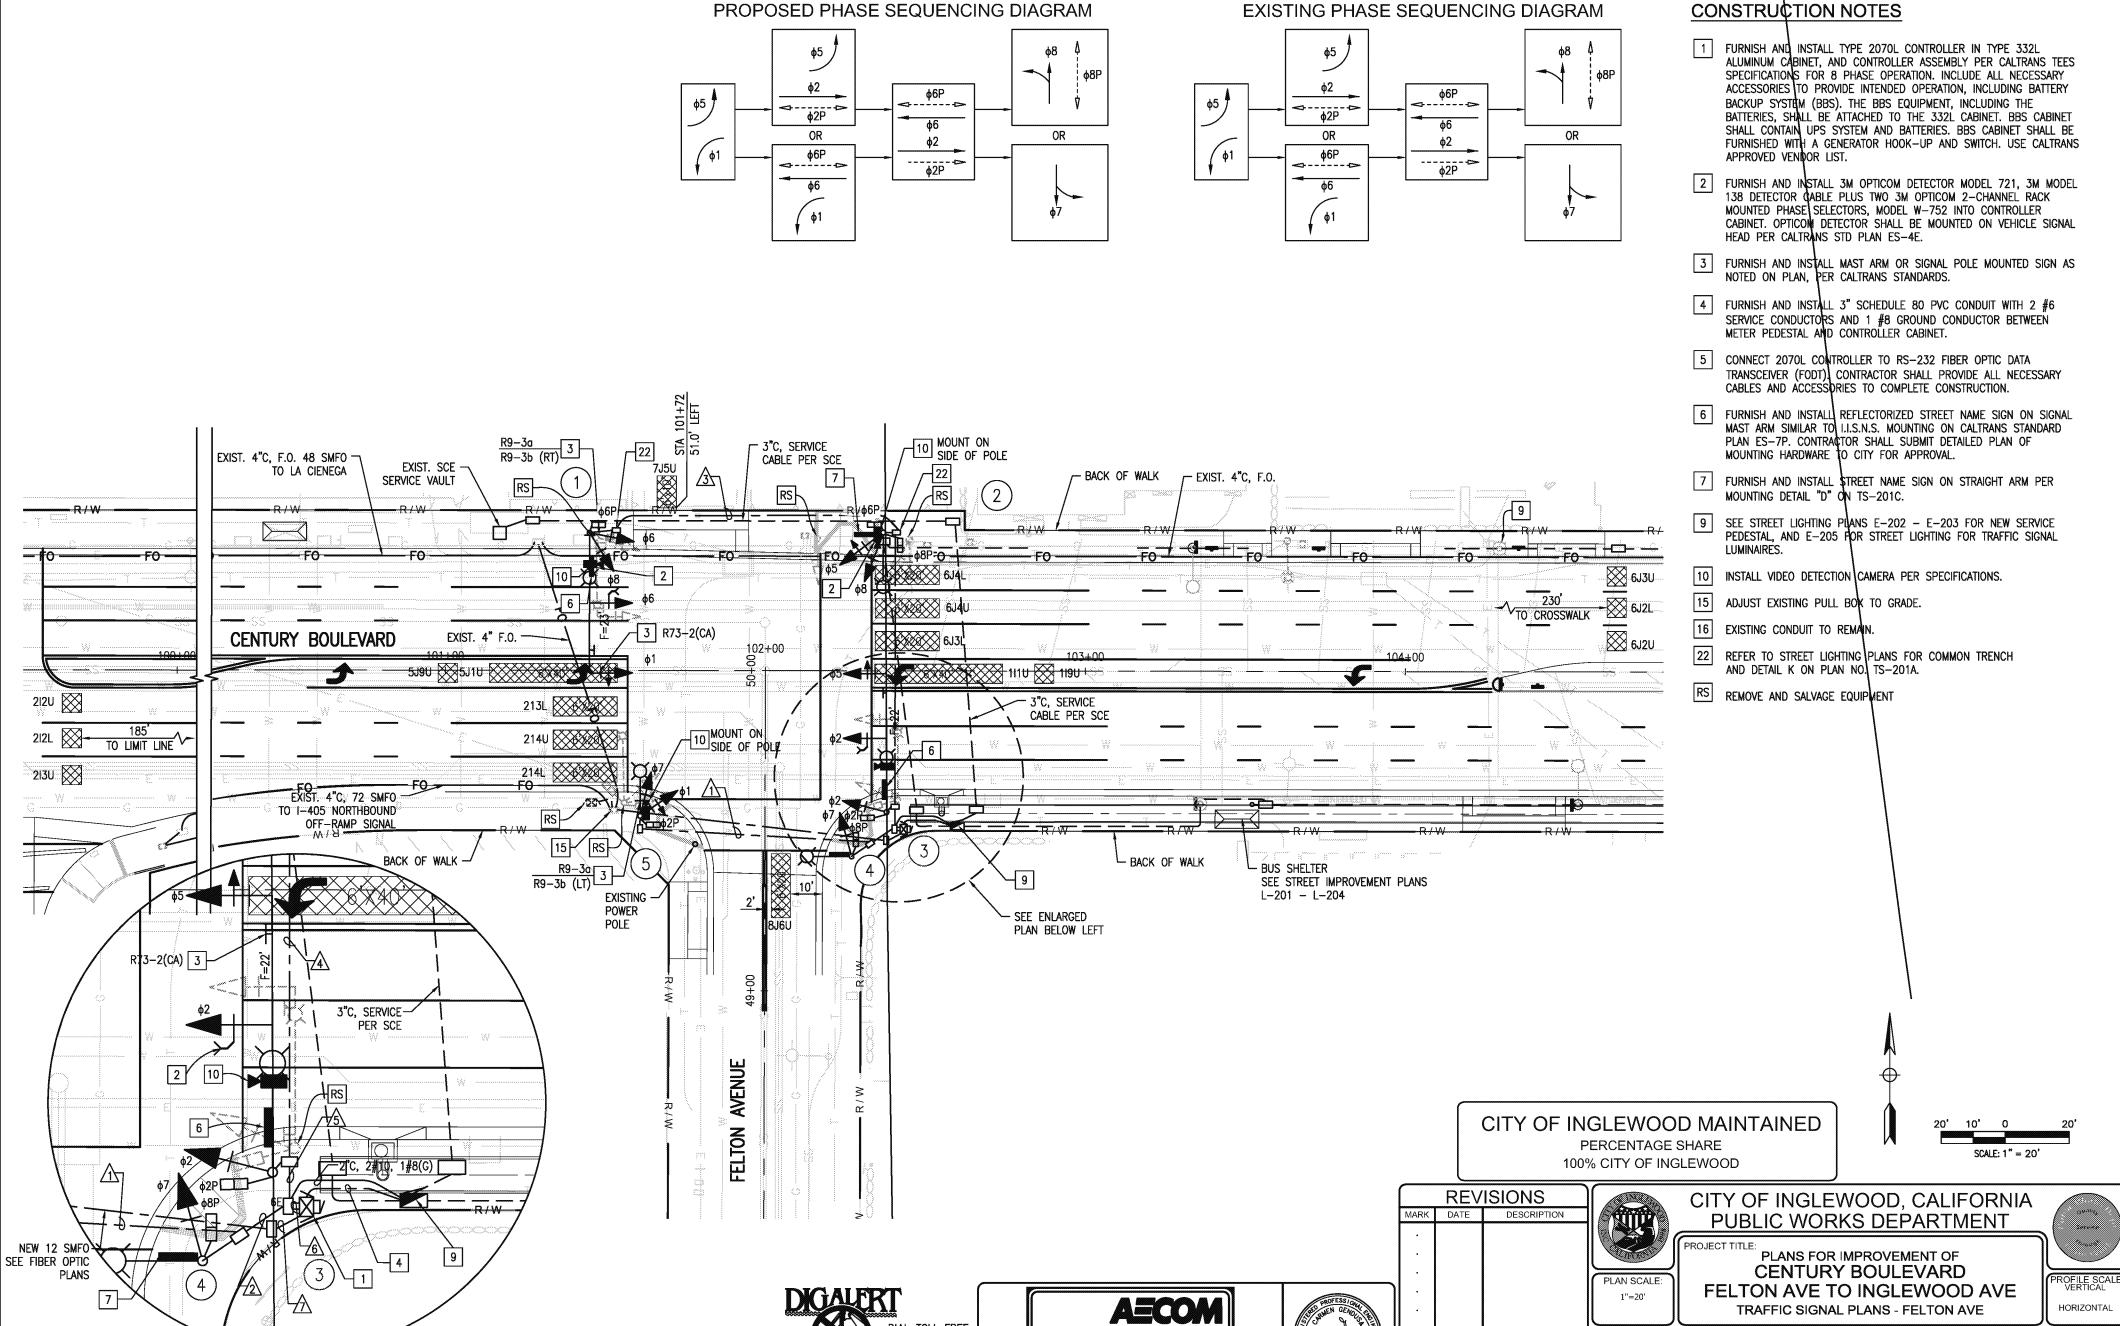
PUBLIC WORKS DEPARTMENT PROJECT TITLE: PLANS FOR IMPROVEMENT OF CENTURY BOULEVARD FELTON AVE TO INGLEWOOD AVE

TRAFFIC SIGNAL PLANS - DETAILS

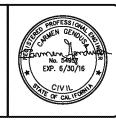CITY OF INGLEWOOD, CALIFORNIA

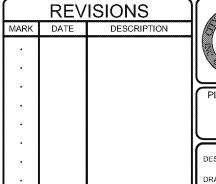5/18/2015

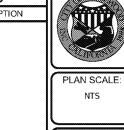TS-201C SHEET NO. 35 OF 67



AECOM Technical Services, Inc. 515 S. FLOWER ST., 4th FLOOR LOS AMBELES, CA 90071 T 213.330.7200 F 213.330.7200

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UNDERGROUND SERVICE ALERT OF SOUTHERN CALIFORNIA

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SCALE: 1"=10'

TS-202

SHEET NO. 36 OF 67

5/18/2015

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POLE AND EQUIPMENT SCHEDULE															
STANDARD			LED			CICIVIE MICCITIIIC		PED PUSH BUTTON (2) SEE DETAIL "C" *		POLE LO	CATION FAIL "B" *				
NO. -	TYPE	HEIGHT	SIGNAL M. A.	LUM. M. A.	LUMINAIRE	R.S.N.S LEGEND	M. A.	POLE	PED (1)	QUAD.	REMAI	REMARKS			
1	26-4-100	30'	45'	12'	196W	Felton	2-MAS	SV-2-TA	SP-1-T	1	6		STA 101+48	5'	POLE FOUNDATION TO CELAR EXIST VAULT STRUCTURE BY MIN. 1 FOOT
2	15TS	30'	_	12'	196W	Century	_	SV-2-TA	SP-2-T	$\frac{1}{2}$	6 8		STA 102+36	7'	
3	26-4-100	30'	45'	12'	196W	Felton ———	2-MAS	SV-1-T	SP-1-T	4	8		5'	4.5'	
4	15TS	30'	_	12'	196W	Century	_	SV-1-T	SP-1-T	1	2		6'	8'	
(5)	15TS	30'	_	12'	196W	-	_	SV-2-TA	SP-1-T	3	2		5'	3'	

ALL SIGNAL EQUIPMENT IS NEW UNLESS NOTED OTHERWISE.

* SEE SHEET TS-201C

(1) LED COUNT DOWN PEDESTRIAN SIGNAL FACE

(2) ACCESSIBLE PEDESTRIAN SIGNAL

CONDUCTOR AND CONDUIT SCHEDULE										
AWG SIZE	CONDUIT LOCATION									
OR CABLE TYPE	POLE & PHASES	$\overline{\Lambda}$	2	3	4	<u>/</u> 5	6	*/7\		
12	① -\$1, \$6, \$8, \$6P, \$6PPB	-/-	-/-	2/1	2/1	2/1	2/1	-/-		
CABLE	② - ф5, ф8, ф6P, ф8P, ф6PPB, ф8PPB	-/-	-/-	-/-	1/2	1/2	1/2	-/-		
11-#14 1-#12	③ −¢2, ¢5, ¢2P, ¢8PPB	-/-	-/-	-/-	-/-	1/1	1/1	-/-		
	Ф -ф7, ф8Р, ф2РРВ	-/-	1/1	-/-	-/-	-/-	1/1	-/-		
(3-#14, PPB)	⑤ −¢1, ¢7, ¢2P, ¢2PPB	1/1	1/1	-/-	-/-	-/-	1/1	-/-		
CABLE	TOTALS: 12 CONDUCTOR / 3 CONDUCTOR	1/1	2/2	2/1	3/3	4/4	6/6	-/-		
#10	LUMINAIRES	2	4	4	4	4	_	-		
VIDEO	DETECTION CABLE	1	_	1	2	1	4	_		
	EV CABLE	_	_	1	2	1	3	_		
1:	2 SMFO CABLE	_	_	_	_	_	_	1		
C	CONDUIT % FULL			21	18	21	16	-		
	CONDUIT SIZE	3"	3"	3"	4"	4"	2-4"	3"		


NOTE: ALL CONDUCTORS CABLE AND CONDUITS ARE NEW UNLESS NOTED OTHERWISE.

* SEE FIBER OPTIC PLANS FOR CONDUIT SIZE, F.O. CABLE LOCATIONS

PERCENTAGE SHARE 100% CITY OF INGLEWOOD CITY OF INGLEWOOD, CALIFORNIA

	REVISIONS							
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and Darrowskiller								
No. 54933 P. 6/30/16								

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PUBLIC WORKS DEPARTMENT

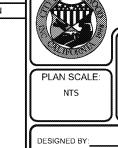PLANS FOR IMPROVEMENT OF CENTURY BOULEVARD FELTON AVE TO INGLEWOOD AVE TRAFFIC SIGNAL PLANS - FELTON AVE

5/18/2015 DATE

CITY OF INGLEWOOD MAINTAINED

TS-202A SHEET NO. 37 OF 67

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